

MONTEREY PENINSULA WATER MANAGEMENT DISTRICT

**ADDENDUM NO. 2
TO
CONTRACT DOCUMENTS**

**For Construction
Of
SANTA MARGARITA WATER TREATMENT FACILITY PROJECT**

GENERAL

Scope

The following revisions are made to the Contract Documents and its attachments for the subject project.

This Addendum (including attachments), dated September 6, 2019, includes 21 pages.

ADDITIONAL INFORMATION

Reminder that the **bid opening date and time** are Thursday September 19, 2019 at 2:00 p.m. The location will be the same at 5 Harris Court, Building G, Monterey, CA 93940.

A mandatory pre-bid meeting was held on August 27, 2019. Minutes are included as part of this Addendum.

REVISIONS

Item No. 1

The mandatory pre-bid meeting minutes and attendance sheet are included as Exhibit A of this Addendum 2.

Item No. 2

The District estimate for all work described in this bid is approximately three million dollars (\$3M).

Item No. 3

Contractor's Experience Qualifications

Delete the second paragraph in the in its entirety:

“The Prime Contractor or its subcontractor for the water supply works must have completed two (2) projects constructing potable water supply works with piping and appurtenances within the last ten (10) years.”

Add the following in its entirety:

“The Prime Contractor must have completed two (2) projects of similar scope including pipeline and plant work within the last ten (10) years.”

Item No. 4

General Conditions, 11.08 Liquidated Damages

Replace *“one thousand dollars (\$1000) per day for each and every calendar day's delay beyond the time prescribed”*

with *“one thousand seven hundred dollars (\$1700) per day for each and every calendar day's delay beyond the time prescribed”*

Item No. 5

Special Conditions, 1. Owner Furnished Equipment

Add the following in its entirety:

“The Contractor shall coordinate and provide labor and equipment for delivery off-loading and secure storage of Owner Furnished Equipment at no additional cost to the Owner.

The Contractor shall provide all labor, materials, tools, and supplies necessary to install Owner Furnished Equipment at no additional cost to the Owner.

The Contractor shall coordinate commissioning, training, and start-up support for Owner Furnished equipment at no additional cost to the Owner; the Owner has paid the vendor for commissioning, training, and start-up support, the Contractor is responsible only for coordination.”

Item No. 6

Special Conditions, 7 Trailer and Sanitation

Delete the following in its entirety:

“Power, internet service, water, and all supplies required in the office facilities shall be provided by the Contractor at no additional cost to MPWMD. The existing facility does not have available power, internet service, water, or sanitation facilities.”

Add the following in its entirety:

“Limited power and water are available at the work site at no additional cost to the Contractor. If the site power or water supply are insufficient for the Contractor’s needs, the Contractor shall supply the required power or water supply at no additional cost to MPWMD. If Contractor use of power or water causes any problems with site operation, the Contractor shall supply the required power or water supply at no additional cost to MPWMD.”

Sanitation facilities, internet service, and all supplies required for the office facilities shall be provided by the Contractor at no additional cost to MPWMD.”

Item No. 7

Special Conditions, 11 Operations

Add the following in its entirety:

“Contractor must give Owner and Construction Manager at least 72 hours advance notice of work impacting Operations, including tie-in to the north and south 30” pipelines. Tie-ins to pipelines required for water production must be performed within a 24 hour period.”

Item No. 8

Special Conditions, 13 Inspections

Delete the paragraph in its entirety.

Add the following in its entirety:

“Geotechnical and other special inspections must be coordinated with the Owner and the Construction Manager with sufficient notice to facilitate inspection, minimum of 48 hrs. Owner and/or Owner’s representative, CM, will be responsible for geotechnical inspection, material testing and special structural inspections including but not limited to concrete, reinforcing, and anchor installations. However, the Contractor will be responsible for coordinating with the Construction Manager or Owner for scheduling required inspections. The Contractor shall not proceed with additional work associated with the inspected works without Owner’s express consent.”

Item No. 9

Special Conditions, 16 Completion

Add the following in its entirety to the first paragraph:

“Substantial completion includes all instrumentation, wiring, and electrical work such that the Owner/Operator can install and commission SCADA. SCADA, to be installed by others, is not part of substantial completion for this contract, wiring and electrical are part of this contract.”

Item No. 10

Construction Plans and Drawings

Delete drawings C7, C9, C10, C11, C13, A101, A111, and A401 and replace with the drawings supplied as Exhibit 2 to this Addendum 2.

QUESTIONS AND RESPONSES

None in this Addendum.

Exhibit A

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+Santa Margarita Water Treatment Facility Project
Mandatory Pre-bid Meeting 27 August, 2019

1. Introduction
2. Project Team
 - a. Maureen Hamilton, MPWMD, Project Manager
 - b. Steve Tanner, Pueblo Water Resources, Designer
 - c. Jon Lear, MPWMD, Operations Manager
 - d. Dave Norris, Cal Am Representative
3. Bidding and Contract Schedule
 - a. Bid Opening Date: September 19, 2019, 2:00 p.m. at 5 Harris Court, Building G, Monterey, CA 93940
 - b. Last day for Questions: September 12, 2019, 5:00 p.m.
 - c. Estimated Board Approval for Award: October 21, 2019
 - d. Notice of Award, Notice to Proceed
 - e. Contract Time: Substantial completion by June 30, 2020.
4. Bidder Qualifications & Requirements
 - a. Bid Acknowledgement
 - i. Sign that all addenda have been received or attach all addenda with bid.
 - b. Bid Form
 - i. Owner purchased materials – we are NOT purchasing the Prominent analyzer. We are purchasing the chemical feed skids. In an addendum we will ask that some lettering be installed on a wall; we have purchased that lettering.
 - c. Subcontractor's Designation Form
 - d. Prevailing wages, insurance, bonds – This is a prevailing wage job. This project is not being funded by any grant nor state revolving fund loan. Bid bond, performance and material bonds, and a 50% maintenance bond. The City of Seaside has its own insurance requirements; MPWMD is not responsible for the City requirements.
 - e. Experience
5. Payments & Retainage
 - a. Bonds
 - b. Release of Lien
 - c. Monthly Payments
 - d. 5% Retainage
 - e. Liquidated Damages – currently set at \$1000/day. This is subject to change in a future addendum.
6. Bidder Requirements - Project

a. Special Conditions

- i. Owner furnished equipment and substitutions – update issued in Addendum 1, please read carefully.
- ii. Permits – license, grading, encroachment
 1. Grading permit costs – handout was given from City of Seaside official detailing calculation for the grading permit. Calculation and cost negotiations are between the Contractor and the City; MPWMD is not involved in nor responsible for grading permit costs and cost negotiations. MPWMD will work with City in advance of the bid to get the grading permit initiated.
- iii. Fort Ord, MRP – we are constructing on a former munitions range. Unexploded ordnance (not a typo) also known as UXO training is required. Training is now on-line. Soil management is critical. Soil may not be exported from site. There is a “TIP” line shown in some civil drawings that indicates where soil to the west may not be moved east. The CEQA Mitigation Reporting Program is given in the Call for Bids. A biologist is not required.
- iv. SWPPP – MPWMD has a SWPPP. The land calculations show we are disturbing less than one acre. Please review the special conditions carefully. If stockpiles are located such that the disturbed acreage exceeds 1 acre, the Contractor will be responsible for Construction General Permit requirements detailed in the Special Conditions.
- v. Trailer, Utilities –
- vi. Neighbors – during our last project we got no noise complaints and numerous vibration complaints. Please read the plans, specifications, and special conditions carefully. When sheepsfooted rollers were used, and when excavating through a sand stone layer, we received multiple calls about vibration. Neighbors reported windows and glasses vibrated excessively. The Contractor is expected to respond to neighbor complaints by reducing the intensity and/or use of vibration equipment to a level acceptable to the neighbors. Please plan accordingly.
- vii. O&M – construction will be performed while the facility is operating. There are two tie-ins that need to be made that will interrupt operation. MWPMMD expects to issue an Addendum detailing acceptable outages.

b. Operating facility

c. Addenda

7. Description of Work (Steve)

Scada is not in this scope. A cabinet will need to be moved and installed; conduit and signal wire routed to the cabinet in the new building.

8. Questions from Bidders

Addenda will be uploaded to the web and sent via email to the email addresses given on the sign-in sheet at this pre-bid meeting.

Visited MCC

Visited the stockpile area used for the backflush basin expansion

Questions:

What size sheepfooted roller received the vibration complaints? 84 inches.

DRAFT

Monterey Peninsula Water Management District Santa Margarita Water Treatment Facility

Mandatory Pre-Bid Meeting Sign-In Sheet (27 August, 2019 – 10:00am)

CONTRACTOR	Anderson Pacific
Contact Name	Sean McBurney
Address	1390 Newman Ave Santa Clara, CA
Telephone	(408) 529-9818
Fax	
Email	smc@andpac.com
CONTRACTOR	Brough Construction Inc
Contact Name	Jeff Brough
Address	634 printz RD Arroyo Grande, CA 93420
Telephone	805 489 7779
Fax	
Email	estimators@broughconstruction.com Mark@broughconstruction.com
CONTRACTOR	MERCER-FRASER COMPANY
Contact Name	MARK BENZINGER
Address	PO Box 1006 EUREKA CA 95502
Telephone	707-599-6371
Fax	707-443-0277
Email	mbenzinger@mercerfraser.com
CONTRACTOR	Specialty Construction Inc.
Contact Name	Tom Seidel
Address	645 Clarion Ct. SLO CA 93401
Telephone	805-543-1706
Fax	805-543-1722
Email	tseidel@specialtyconstruction.com

CONTRACTOR	MFE
Contact Name	MIKE BARTHEL
Address	192 HEALY AVE, MARINA
Telephone	813-384-4081
Fax	813-384-5078
Email	MIKE@MFE2000.COM
CONTRACTOR	DNC COMMERCIAL INC
Contact Name	Dan McAwcey
Address	194 Sky Park Dr. Monterey 93940
Telephone	831-656-1600
Fax	831-717-4315
Email	dan@dncmp.com
CONTRACTOR	
Contact Name	
Address	
Telephone	
Fax	
Email	
CONTRACTOR	
Contact Name	
Address	
Telephone	
Fax	
Email	

Exhibit B

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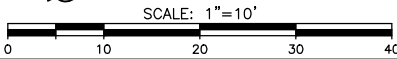
CONSTRUCTION NOTES

- 1
- CONSTRUCT 8" TYPE S HDPE STORM DRAIN.
- 2
- CONSTRUCT 4" TYPE S HDPE STORM DRAIN.
- 3
- NOT USED
- 4
- NOT USED
- 5
- CONNECT 8" HDPE TO EXIST 8" HDPE. CONTRACTOR TO VERIFY EXIST DEPTH AND LOCATION OF EXIST 8" HDPE.
- 6
- CONSTRUCT 6" TYPE S HDPE STORM DRAIN.
- 7
- CONSTRUCT LOADING RACK SUMP 4' O.D. X 4' DEEP WITH 24" STANDARD MANHOLE COVER PER SECTION "D" SHEET C13
- 8
- CONSTRUCT BROOKS PRODUCT CB-1818 18"x18" CATCH BASIN WITH GRATE (ADA COMPLIANT) OR APPROVED EQUAL BY THE OWNER.
- 9
- ADJUST EXISTING UTILITY VALVES, VAULT LIDS, TO GRADE AS REQUIRED
- 10
- EXIST FIBER OPTICS CABLE WITH CONCRETE CAP. CONTRACTOR TO VERIFY LOCATION AND DEPTH PRIOR TO WORK IN THIS AREA
- 11
- INSTALL 30"x30"x30"DEEP CONCRETE JUNCTION VAULTS FOR CHEMICAL FEED DOUBLE CONTAINMENT LINES. USE ALHAMBRA A-1601B 24" WATER-TIGHT COVER AND FRAME, SEE DETAIL F SHEET C7. SLOPE PVC CONDUITS BACK TO CHEMICAL BUILDING @ MIN. 2% SLOPE. SEE DETAIL J SHEET M4
- 12
- INSTALL 8" RED VALVE CO., TIDEFLEX TF-1 CHECK VALVE ON EXISTING HDPE OUTFALL LINE.
- 13
- INSTALL 4" GATE VALVE, 4" REDUCED PRESSURE BACKFLOW PREVENTION AND RISER ASSEMBLY.
- 14
- CONSTRUCT 6" WIDE GRASSCRETE SLOPE PROTECTION PER MANUFACTURERS RECOMMENDATIONS
- 15
- CONSTRUCT 8" DR17 (PE 4710) HDPE FUSION JOINED STORM DRAIN PIPE. PIPE TO BE PLACED ON TOP OF GRASSCRETE SLOPE PROTECTION. SECURE PIPE WITH PLASTIC PIPE JOINT RESTRAINER ASSEMBLY PER CALTRANS STANDARD DETAIL D87B AT OUTLET AND MID SPAN.
- 16
- CONSTRUCT 2 EACH 2 1/2" SCH 80 DUCTS WITH LONG SWEEP BENDS. INSTALL 2 EACH 0.25" I.D. X 0.35" O.D. PARAFLEX TUBING IN EACH DUCT , ROUTE FROM 16" AND 20" TO ANALYZER ROOM. MOUNT 2 1/2" DUCTS TO INSIDE WALL 24"-36" ABOVE SUB-FLOOR LEVEL.
- 17
- CONSTRUCT 18"x18" LOW PROFILE ADAPTER (PART NO. 1830) WITH 18"x18" ATRIUM GRATE (PART NO. 1881) AND 8" UNIVERSAL LOCKING OUTLET (PART NO. 1888) AS MANUFACTURED BY NDS OR APPROVED EQUAL
- 18
- CONSTRUCT 16"x16"x6" D.I.P. TEE FOR FIRE HYDRANT (MJ W/RESTRAINT)
- 19
- CONSTRUCT 6" D.I.P FIRE HYDRANT LATERAL WITH 42" COVER AND INSTALL STANDARD 2 1/2" X 4" FIRE HYDRANT PER CAL-AM STANDARD DETAILS
- 20
- AIR COMPRESSOR IN ELECTRIC ROOM SEE SHEET C-11
- 21
- LIGHT POLE SEE DETAIL 7 SHEET C6 FOR FOUNDATION, SEE ELECTRIC PLANS FOR ADDITIONAL DETAILS
- 22
- TRANSITION FROM 90" COVER OVER TOP OF PIPE TO 42" COVER OVER TOP OF PIPE
- 23
- 1/2" TYPE K COPPER TUBING WITH 36" MIN. COVER. ROUTE FROM METER VAULT TO SAMPLE STATION SHOWN ON SHEET C11 LOCATE ADJACENT TO RELOCATED AIR-VAC ASSEMBLY.



DATE SIGNED _____

UNAUTHORIZED CHANGES & USES CAUTION:
The engineer preparing these plans will not be responsible for, or liable for, unauthorized changes to or uses of these plans. All changes to the plans must be in writing and must be approved by the preparer of these plans.



SCALE:
HOR. 1"=10'
VER. 1"=N/A

WARNING
IF THIS BAR DOES NOT MEASURE 1" THEN DRAWING IS NOT TO SCALE

DESIGNED STP
DRAWN TLA/FH
CHECKED SPT

MAC Design Associates
CIVIL ENGINEERING * LAND PLANNING * BRIDGE DESIGN
1933 CLIFF DRIVE, SUITE 6, SANTA BARBARA, CALIF. 93109 (805) 967-4748


PUEBLO water resources
Page 13 of 21

Pueblo Water Resources
4478 Market St., Suite 705
Ventura, CA 93003
(805) 644-0470

UTILITY AND PIPING PLAN
MONTEREY PENINSULA WATER MANAGEMENT DISTRICT
SANTA MARGARITA ASR FACILITY SITE EXPANSION
1910 GENERAL JIM MOORE BOULEVARD

PROJECT NO.
W.O. 0451

C7

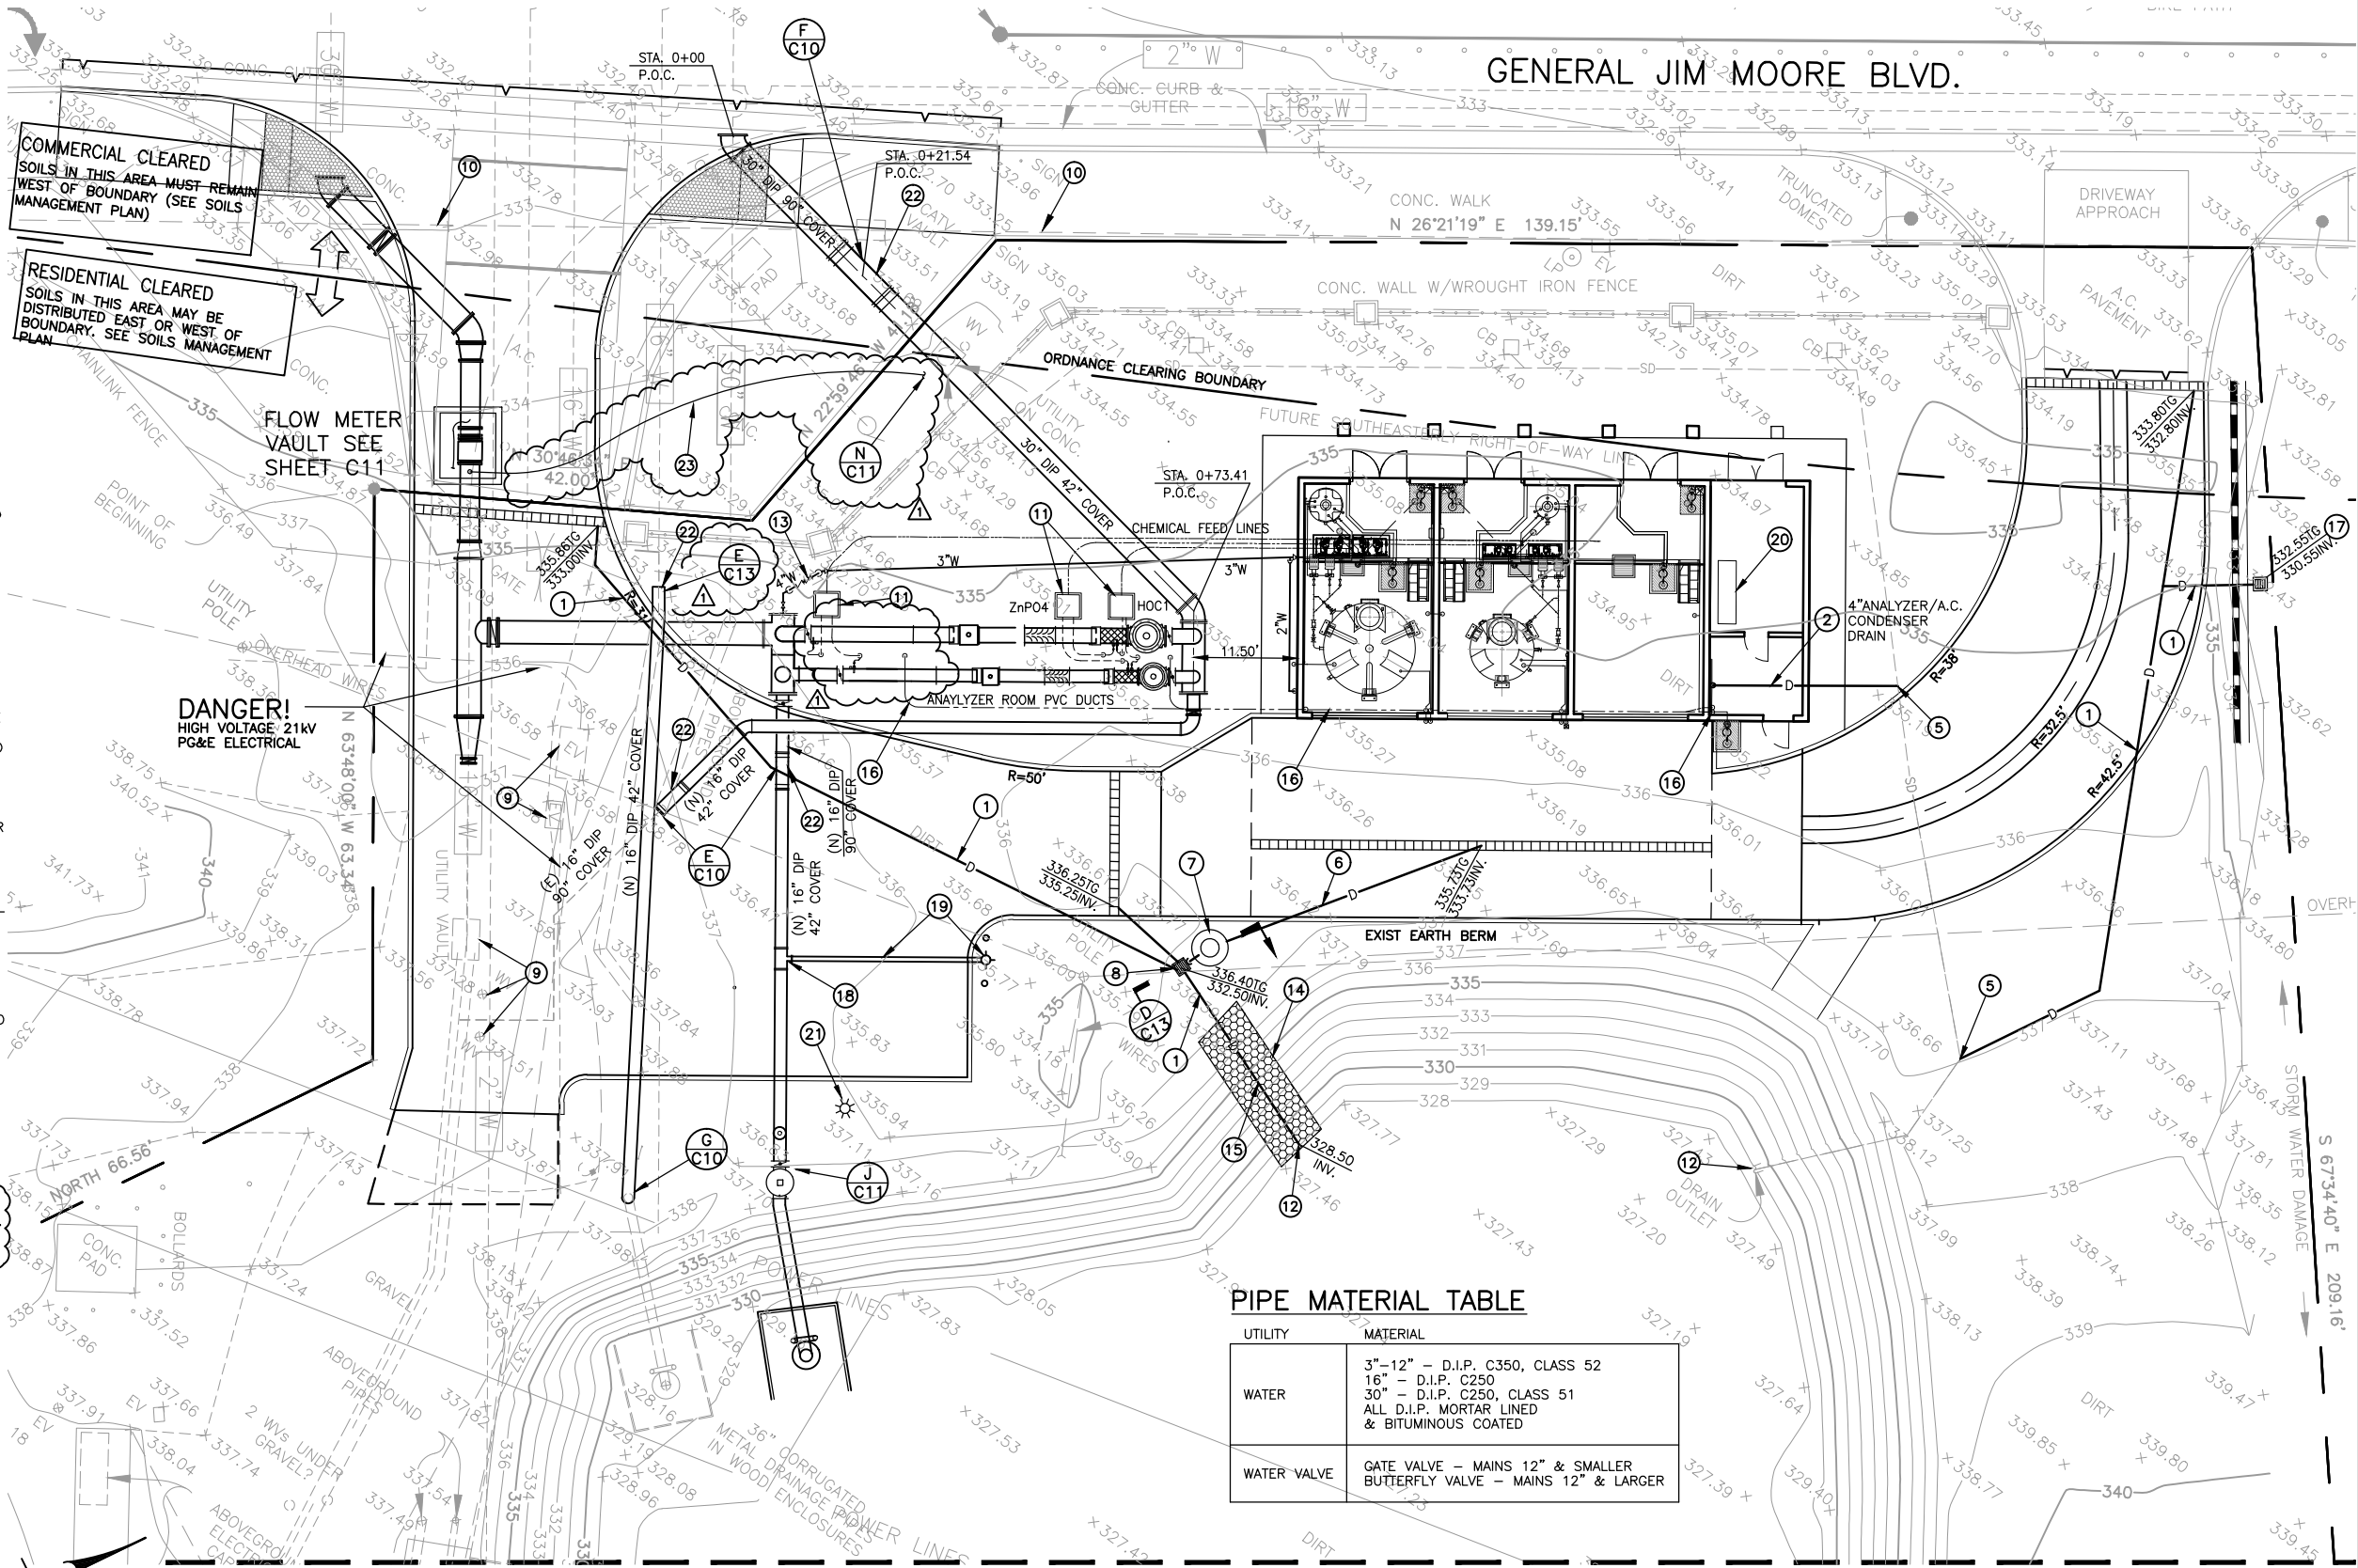

PIPE MATERIAL TABLE


UTILITY	MATERIAL
WATER	3"-12" - D.I.P. C350, CLASS 52 16" - D.I.P. C250 30" - D.I.P. C250, CLASS 51 ALL D.I.P. MORTAR LINED & BITUMINOUS COATED
WATER VALVE	GATE VALVE - MAINS 12" & SMALLER BUTTERFLY VALVE - MAINS 12" & LARGER

MATCH LINE - SEE SHEET C8

CONSTRUCTION NOTES

- CONNECT (N) 16" DIP OSW LINE TO (E) 16" DIP OSW LINE AT 42" BG WITH RESTRAINED 90° BEND (MJ). CUT, CAP, AND ABANDON E 16" DIP OLD LINE IN PLACE. PER DETAIL G SHEET C10
- CONNECT (N) 16" DIP OSW LINE TO (E) 16" DIP OSW LINE AND TRANSITION FROM 90° BG TO 42" BG WITH TWO RESTRAINED 90° BENDS (VERT.). REMOVE (E) 16" DIP OSW RISER AND HDPE LINE. PER DETAIL E SHEET C13
- CONNECT (N) 30" DIP RW LINE TO (E) 30" DIP RW LINE WITH RESTRAINED 45° BEND (MJ) AND TRANSITION FROM 90° BG TO 42" BG WITH TWO RESTRAINED 45° BENDS (MJ) (3 TOTAL). CUT, CAP, AND ABANDON (E) 30" DIP RW LINE IN PLACE. SEE DETAIL C AND F SHEET C10
- RELOCATE (E) AIR VAC ASSY AS NEEDED. CONTRACTOR VERIFY
- (N) 16" DIP OSW W/42" COVER OVER (N) 30" DIP TW LINE (90° COVER)
- (N) 16" OSW W/42" COVER OVER (E) 16" DIP RW LINE.
- CONNECT (N) 16" DIP RW TO (E) 16" DIP RW LINE. REMOVE (E) 16" DIP RISER ASSY AND ASSOCIATED HDPE PIPING.
- CUT, CAP, AND REMOVE (E) 16" DIP RISER ASSY AND ASSOCIATED 18" HDPE PIPING
- 16" BUTTERFLY VALVE, FLANGE
- 30" BUTTERFLY VALVE, FLANGE
- 16" PRESSURE RELIEF VALVE W/SOLENOID OVERRIDE, CLAVAL 50-03 SEE DETAIL J" SHEET C11
- EXIST FIBER OPTIC CABLE WITH CONCRETE CAP. CONTRACTOR TO VERIFY LOCATION AND DEPTH PRIOR TO WORK IN THIS AREA
- CUT CAP AND INSTALL CONCRETE BLOCK OVER ALL ABANDONED IN PLACE LINES SEE DETAIL "H" SHEET C10
- TRANSITION FROM 90" COVER OVER TOP OF PIPE TO 42" COVER OVER TOP OF PIPE. DEPTHS ARE APPROXIMATE.
- CONSTRUCT BOLLARD PER DETAIL G THIS SHEET

16 1/2" TYPE K COPPER TUBING WITH 36" MIN. COVER. ROUTE FROM METER VAULT TO SAMPLE STATION SHOWN ON SHEET C11. LOCATE ADJACENT TO RELOCATED AIR-VAC ASSEMBLY.

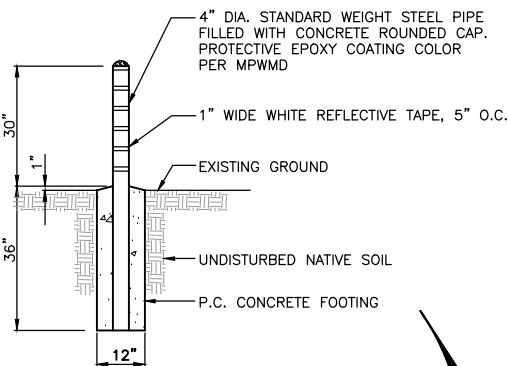

G BOLLARD DETAIL
C9

UNAUTHORIZED CHANGES & USES CAUTION:
The engineer preparing these plans will not be responsible for, or liable for, unauthorized changes to or uses of these plans. All changes to the plans must be in writing and must be approved by the preparer of these plans.

SCALE: 1"=6'
0 6 12 18 24

WARNING
IF THIS BAR DOES NOT MEASURE 1" THEN DRAWING IS NOT TO SCALE

DESIGNED SPT
DRAWN TLA/FH
CHECKED SPT

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PUEBLO water resources
Page 14 of 21

Pueblo Water Resources
4478 Market St., Suite 705
Ventura, CA 93003
(805) 644-0470

16" & 30" TRANSMISSION LINE MODIFICATIONS
MONTEREY PENINSULA WATER MANAGEMENT DISTRICT
SANTA MARGARITA ASR FACILITY SITE EXPANSION
1910 GENERAL JIM MOORE BOULEVARD

PROJECT NO. W.O. 0451
C9

PIPE MATERIAL TABLE

UTILITY	MATERIAL
WATER	3"-12" - D.I.P. C350, CLASS 52 16" - D.I.P. C250 30" - D.I.P. C250, CLASS 51 ALL D.I.P. MORTAR LINED & BITUMINOUS COATED
WATER VALVE	GATE VALVE - MAINS 12" & SMALLER BUTTERFLY VALVE - MAINS 12" & LARGER

GENERAL JIM MOORE BLVD.

WALL FOOTING
EXISTING WALL FOOTING
PROTECT IN PLACE, DO NOT DISTURB

SEE PROFILE
SHEET C13










COMMERCIAL CLEARED
SOILS IN THIS AREA MUST REMAIN
WEST OF BOUNDARY (SEE SOILS
MANAGEMENT PLAN)

FLOW
METER
VAULT

RESIDENTIAL CLEARED
SOILS IN THIS AREA MAY BE
DISTRIBUTED EAST OR WEST OF
BOUNDARY. SEE SOILS MANAGEMENT
PLAN

DANGER!
HIGH VOLTAGE 21kV
PG&E ELECTRICAL



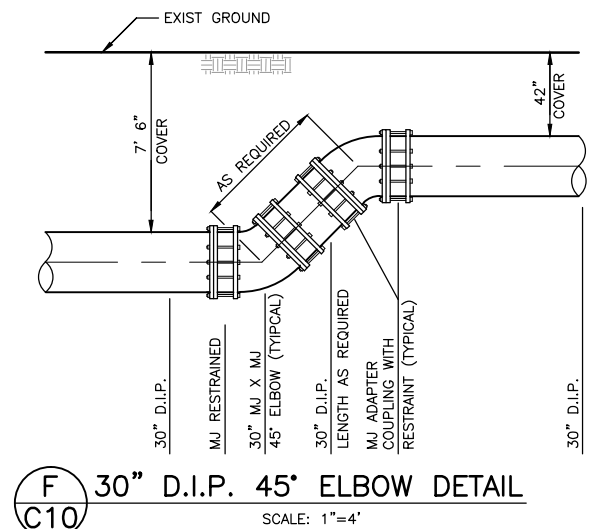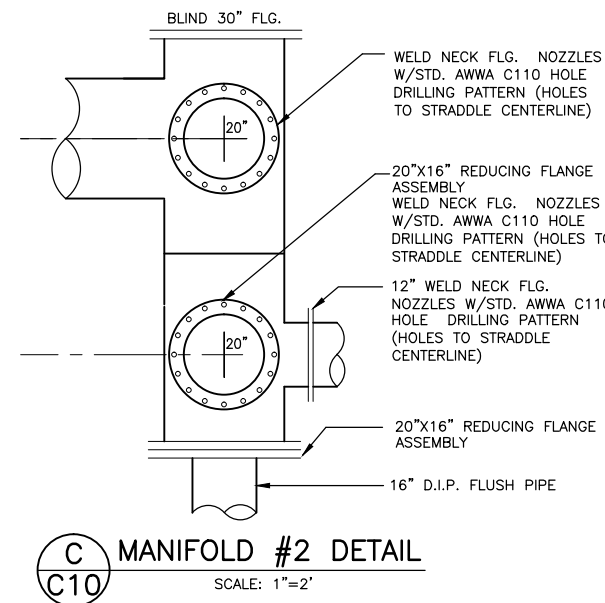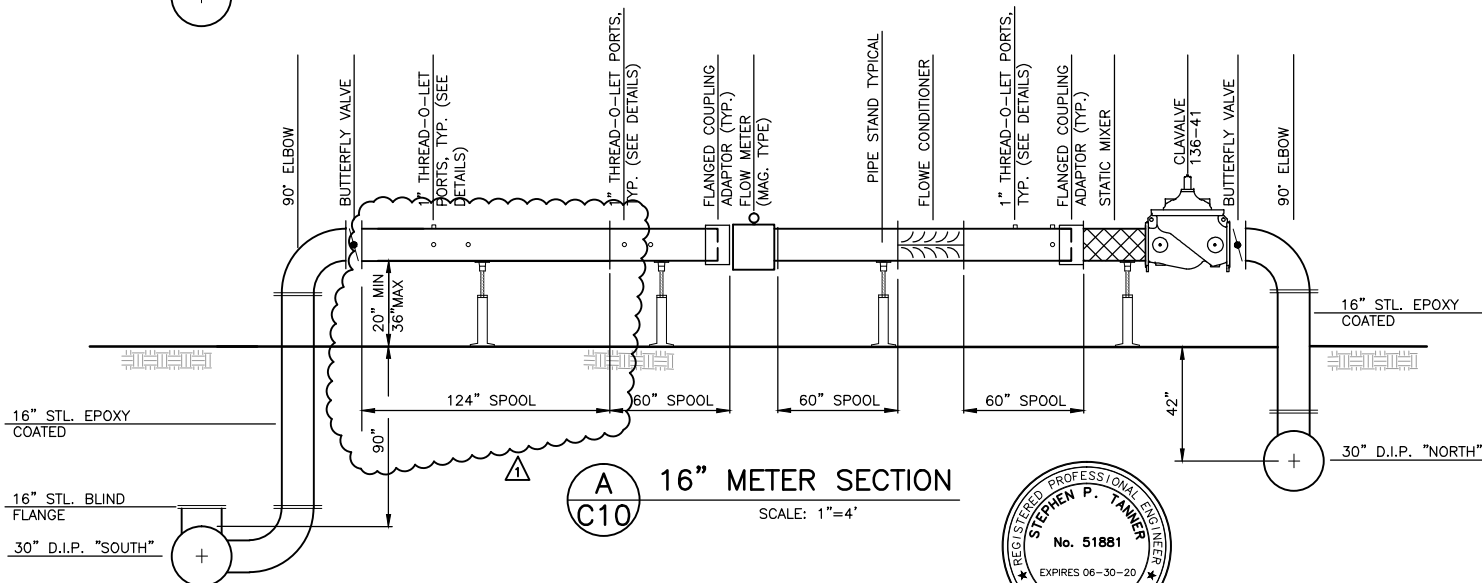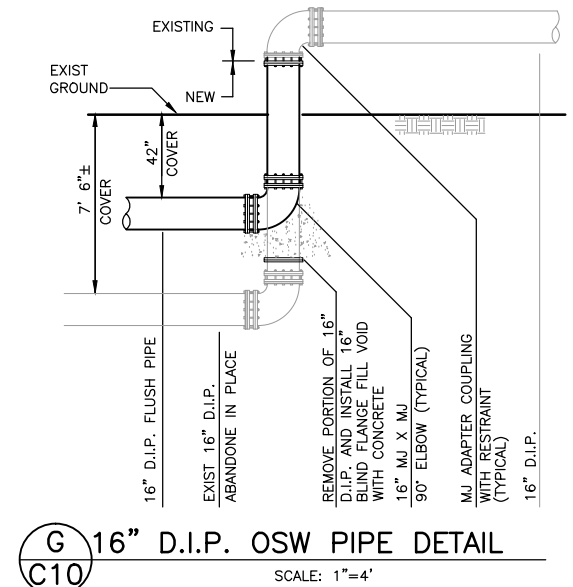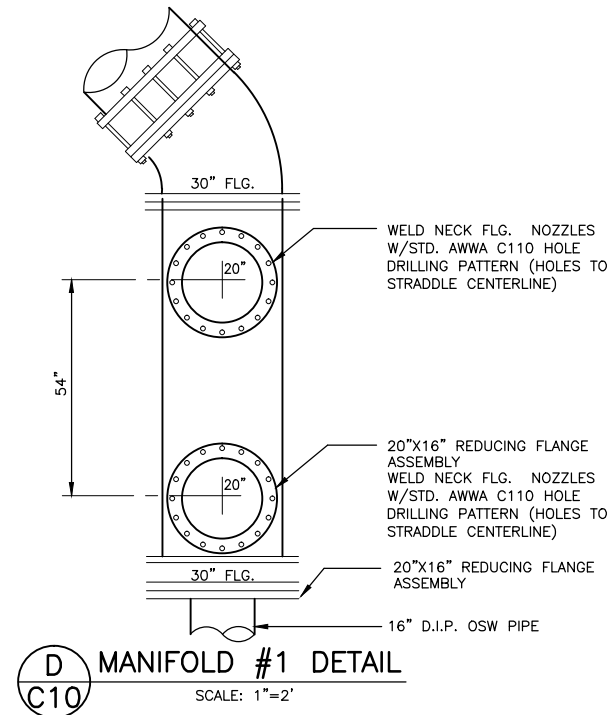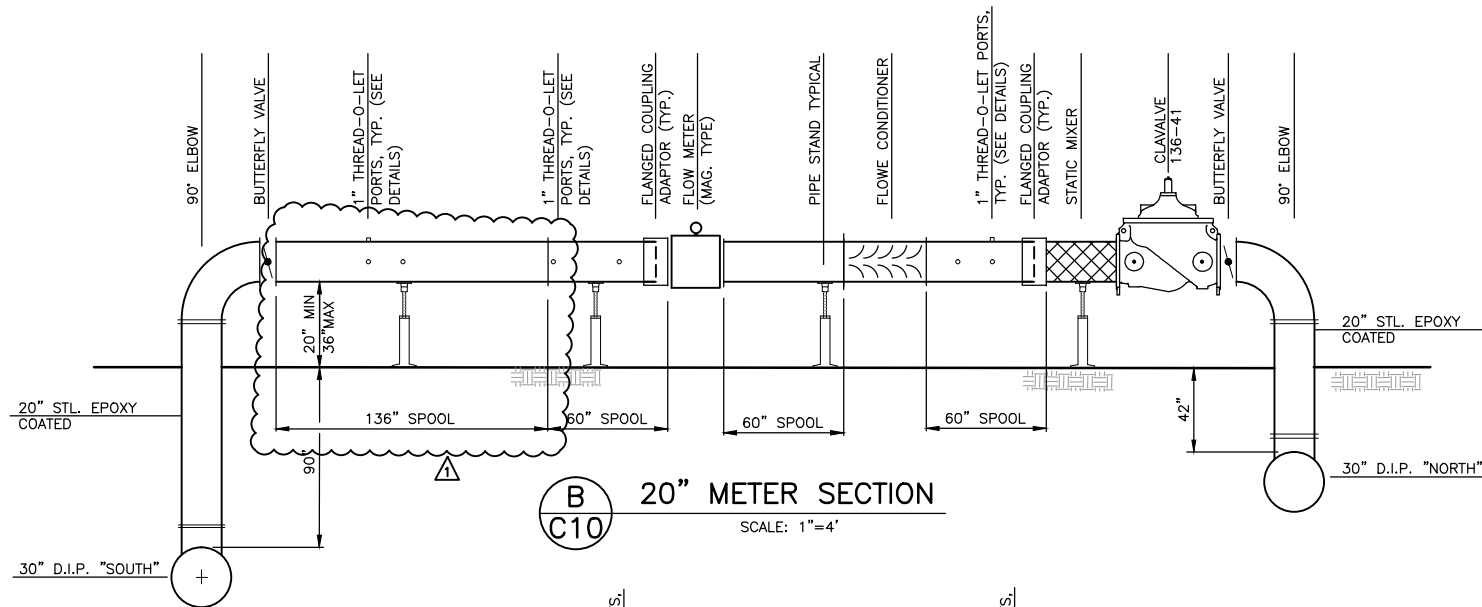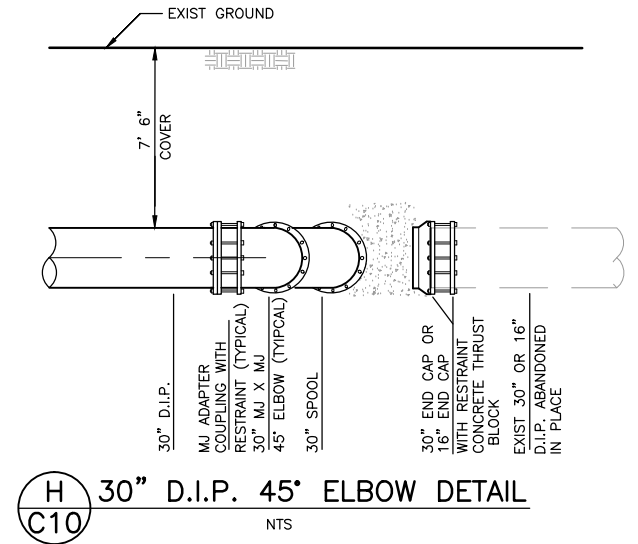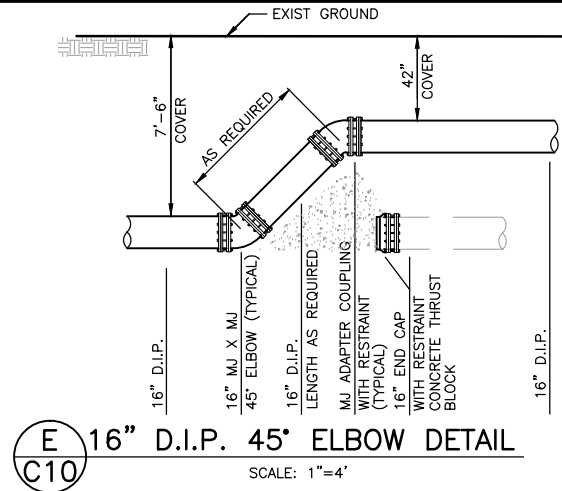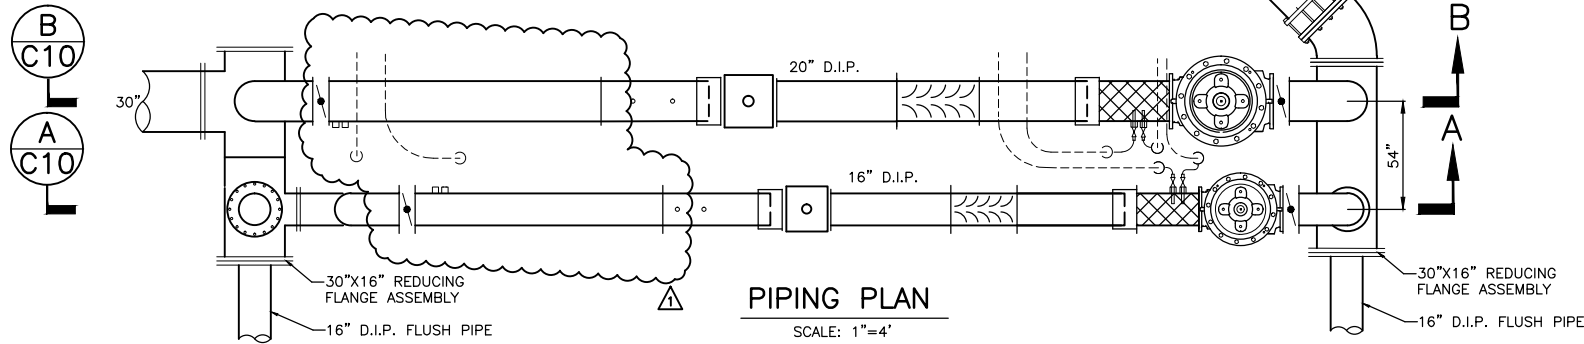

0451UTJLDWG 04/12/19 08:50:21 AM PDT

REV	DATE	BY	DESCRIPTION
09-04-19	SPT	BID ADDENDUM #2	
08-05-19		ISSUED FOR BID	

SCALE:	
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VER.	N/A

WARNING	
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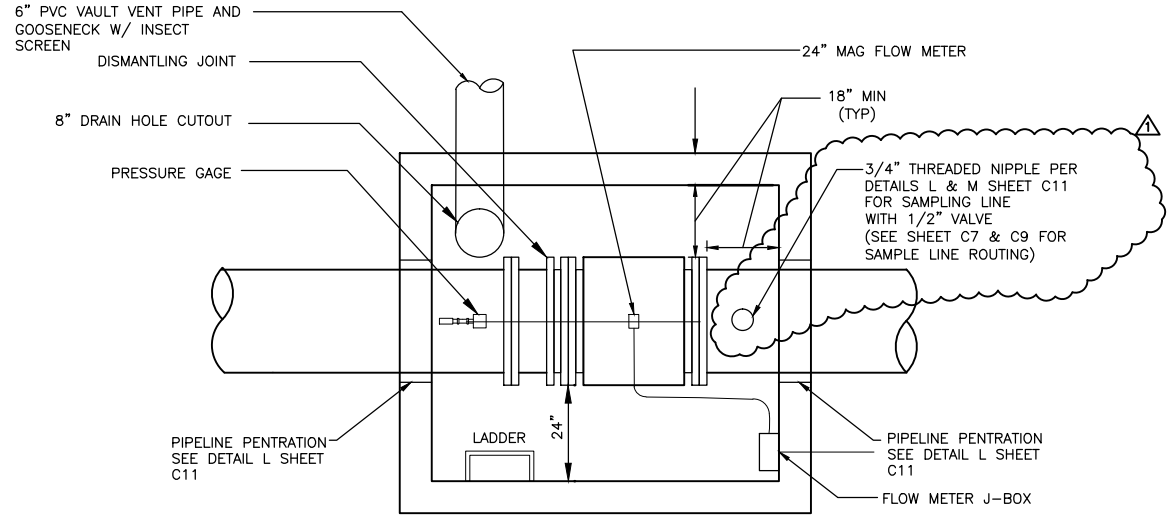
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DRAWN	TLA/FH
CHECKED	SPT

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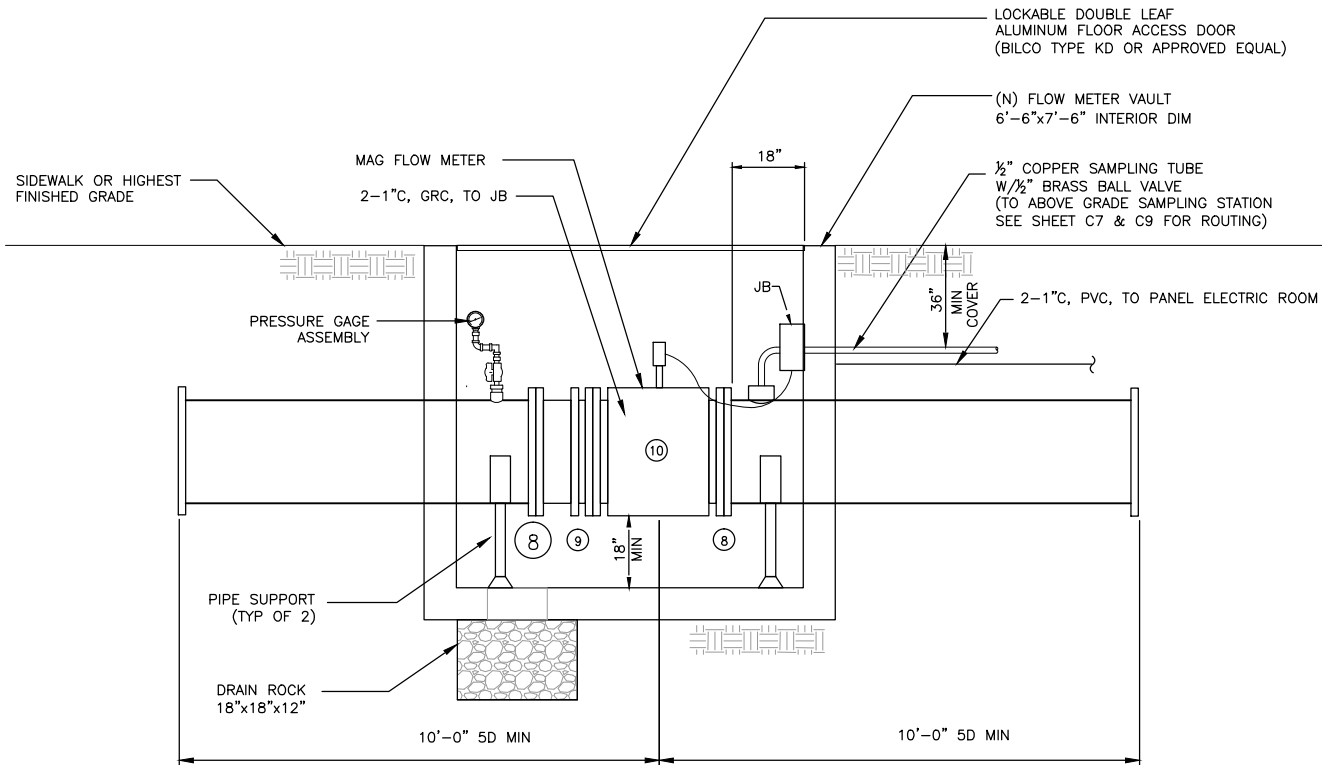
PUEBLO water resources
Pueblo Water Resources
4478 Market St., Suite 705
Ventura, CA 93003
(805) 644-0470

PIPING DETAILS
MONTEREY PENINSULA WATER MANAGEMENT DISTRICT
SANTA MARGARITA ASR FACILITY SITE EXPANSION
1910 GENERAL JIM MOORE BOULEVARD

PROJECT NO.
W.O. 0451
C10




FLOW METER VAULT PLAN
SCALE: 1"=2'




ITEM	DESCRIPTION	MAT	QT
⑧	RESTRAINED FLANGE COUPLING ADAPTER, 24"	DI	2
⑨	DISMANTLING JOINT, FLGxFLG, 24"	DI	1
⑩	MAG FLOW METER, FLGxFLG, 24"	STL	1


SECTION FLOW METER VAULT PLAN
SCALE: 1"=2'

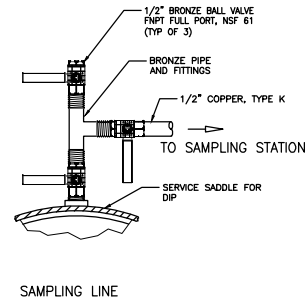


M C11 SAMPLING STATION DETAIL
NO SCALE

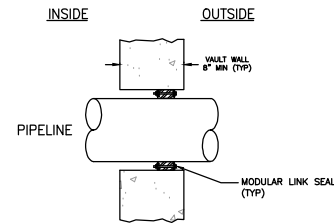


L C11 PIPELINE PENETRATION DETAIL
NO SCALE

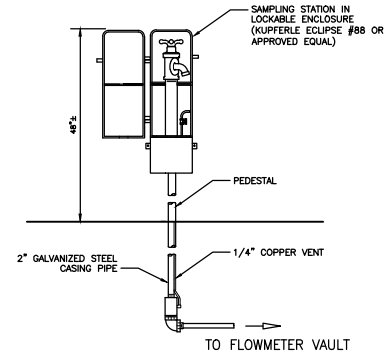

N C11 SAMPLING STATION DETAIL
NO SCALE

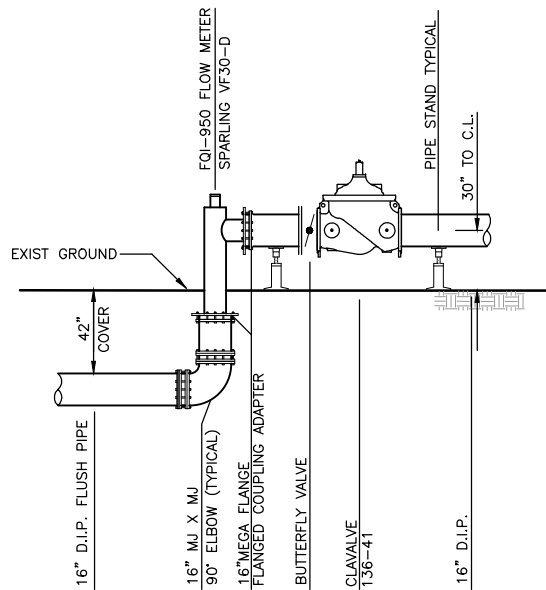

NOTE: SEE DETAIL B SHEET C13 ADDITIONAL INFORMATION
J C11 16" D.I.P. FLUSH PIPE DETAIL
SCALE: 1"=4'

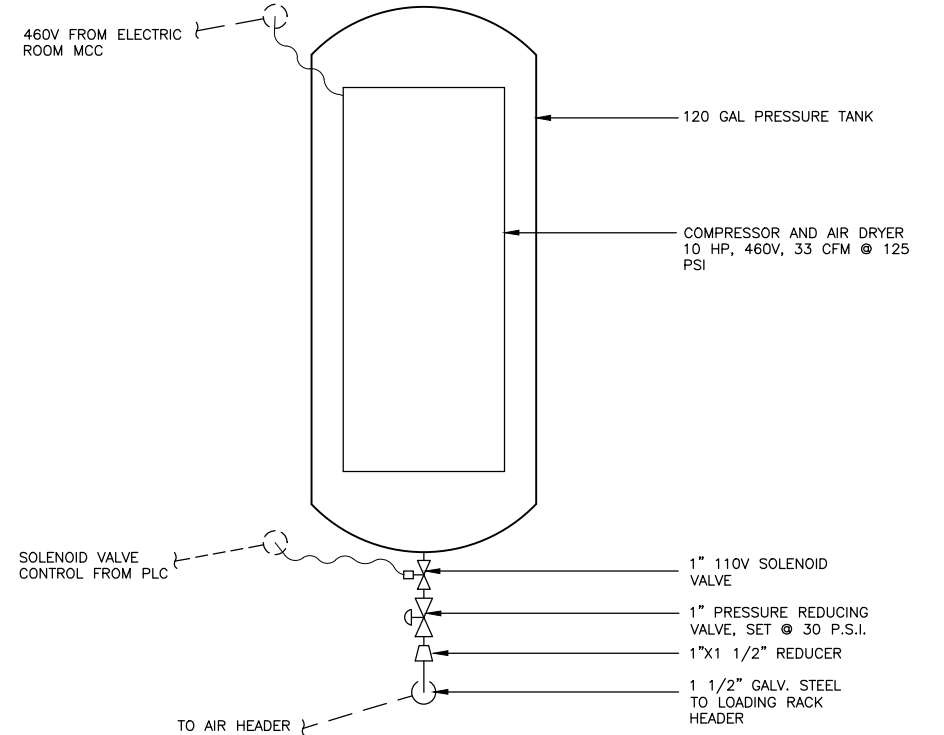

COMPRESSOR DETAIL
SCALE: 1"=1'



DATE SIGNED _____

0451UTJLDWG 04/12/19 08:50:21 AM PDT

REV	DATE	BY	DESCRIPTION
09-04-19	SPT	BID ADDENDUM #2	
08-05-19		ISSUED FOR BID	

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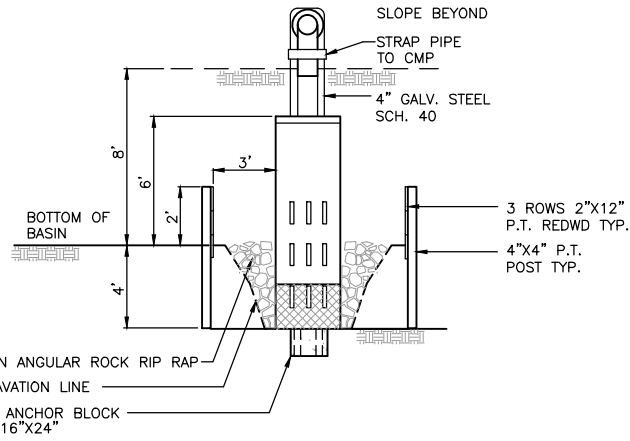
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CHECKED	SPT

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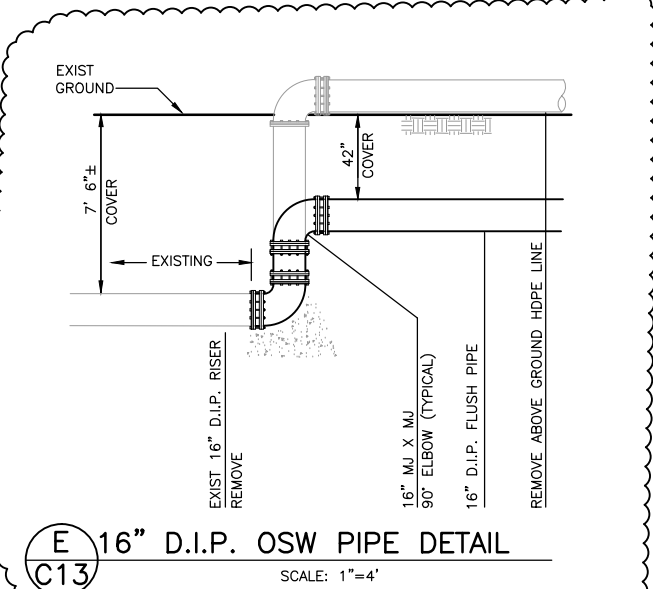
PUEBLO water resources
Pueblo Water Resources
4478 Market St., Suite 705
Ventura, CA 93003
(805) 644-0470

PIPING DETAILS
MONTEREY PENINSULA WATER MANAGEMENT DISTRICT
SANTA MARGARITA ASR FACILITY SITE EXPANSION
1910 GENERAL JIM MOORE BOULEVARD


PROJECT NO.
W.O. 0451
C11




C
C13 ENERGY DISSIPATION CAN AND PIPE SUPPORT
SCALE: 1"=2'




E
C13 16" D.I.P. OSW PIPE DETAIL
SCALE: 1"=4'

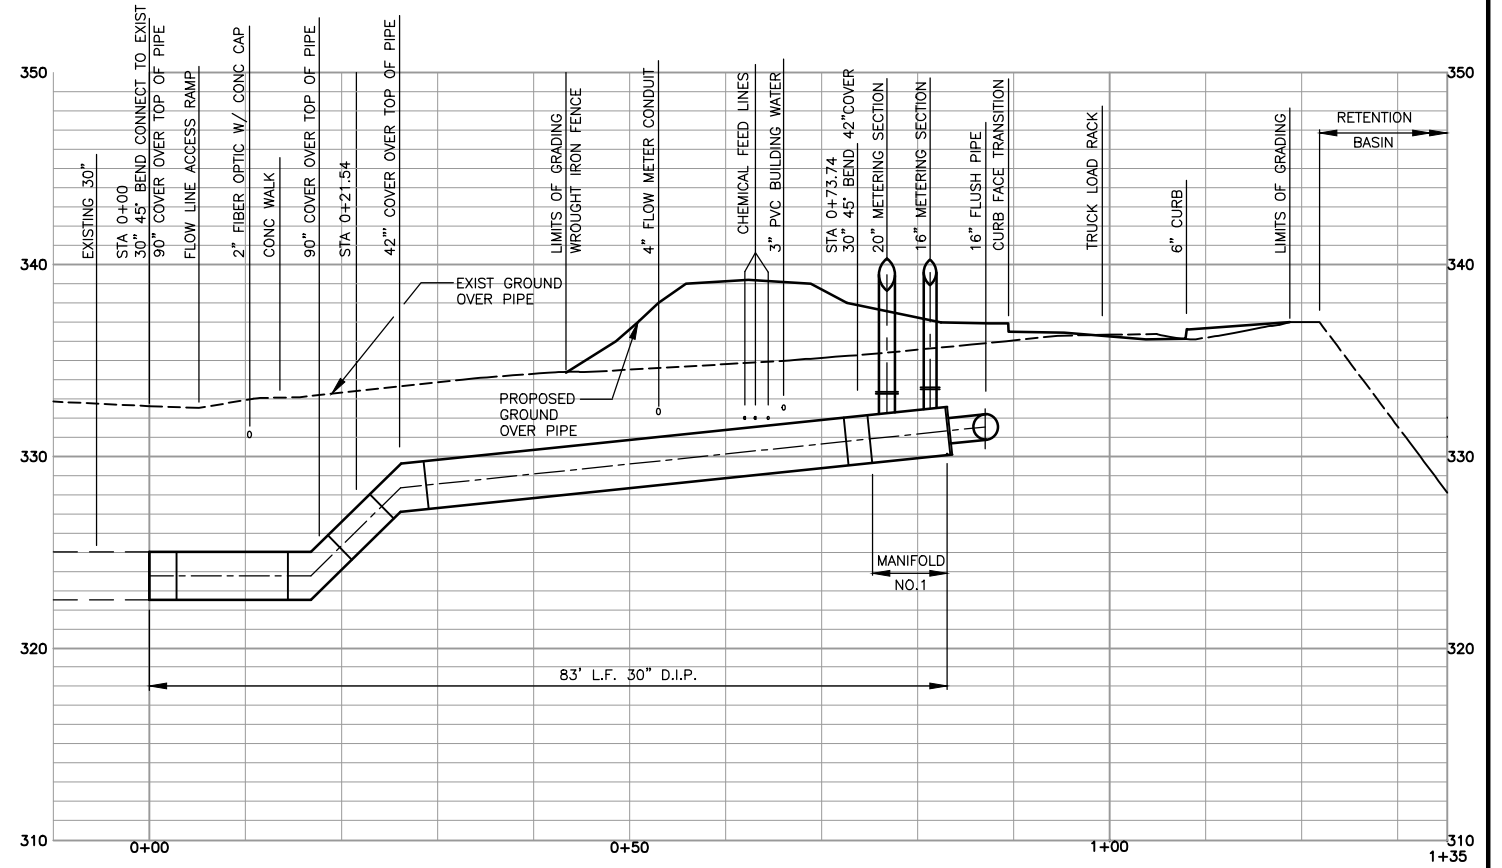


30" TRANSMISSION PIPE PROFILE
SCALE: HORZ. 1"=10'
VERT. 1"=5'

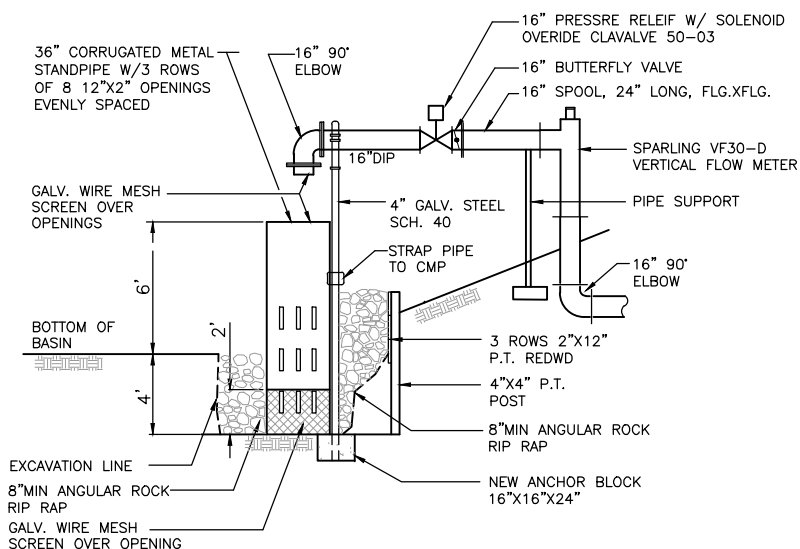


B
C13 SECTION
SCALE: 1"=2'

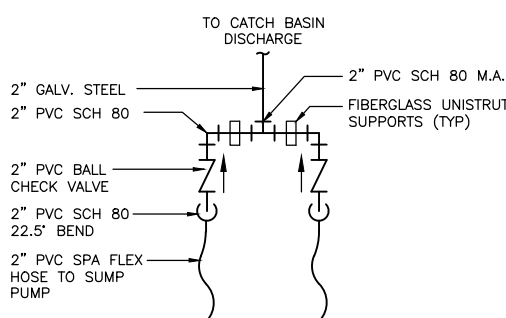


SUMP PIPING DETAIL
SCALE: 1"=2'

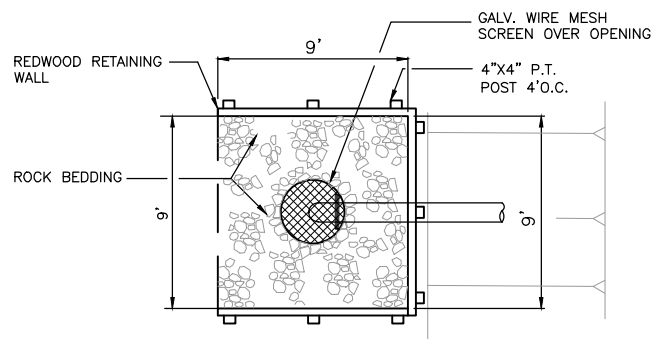

A
C13 PLAN STANDPIPE RETAINING WALL
SCALE: 1"=2'

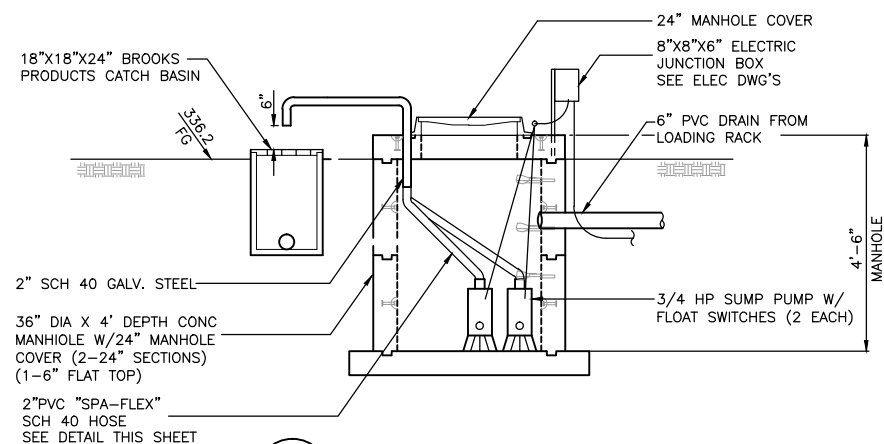

D
C13 SUMP SECTION
SCALE: 1"=2'

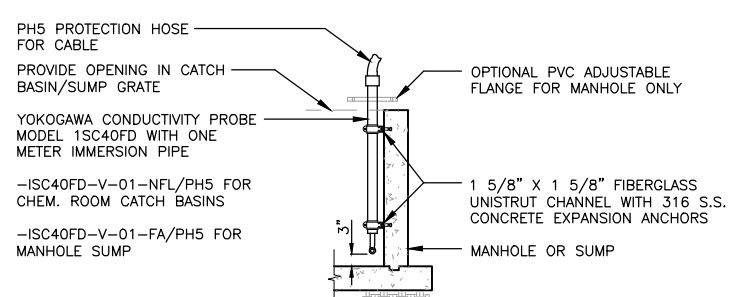

CONDUCTIVITY PROBE MOUNTING DETAIL
NTS



DATE SIGNED _____

0451UTL.DWG 04/12/19 08:50:21 AM PDT

REV	DATE	BY	DESCRIPTION
09-04-19	SPT	BID ADDENDUM #2	
08-05-19		ISSUED FOR BID	

SCALE:
HOR. N/A
VER. N/A

WARNING
0 1/2 1
IF THIS BAR DOES NOT MEASURE 1" THEN DRAWING IS NOT TO SCALE


DESIGNED SPT
DRAWN TLA/FH
CHECKED SPT

MAC Design Associates
CIVIL ENGINEERING * LAND PLANNING * BRIDGE DESIGN
1933 CLIFF DRIVE, SUITE 6, SANTA BARBARA, CALIF. 93109 (805) 957-4748

PUEBLO water resources
Pueblo Water Resources
4478 Market St., Suite 705
Ventura, CA 93003
(805) 644-0470
Page 7 of 21

ENERGY DISSIPATOR AND SUMP DETAILS
MONTEREY PENINSULA WATER MANAGEMENT DISTRICT
SANTA MARGARITA ASR FACILITY SITE EXPANSION
1910 GENERAL JIM MOORE BOULEVARD

PROJECT NO.
W.O. 0451
C13

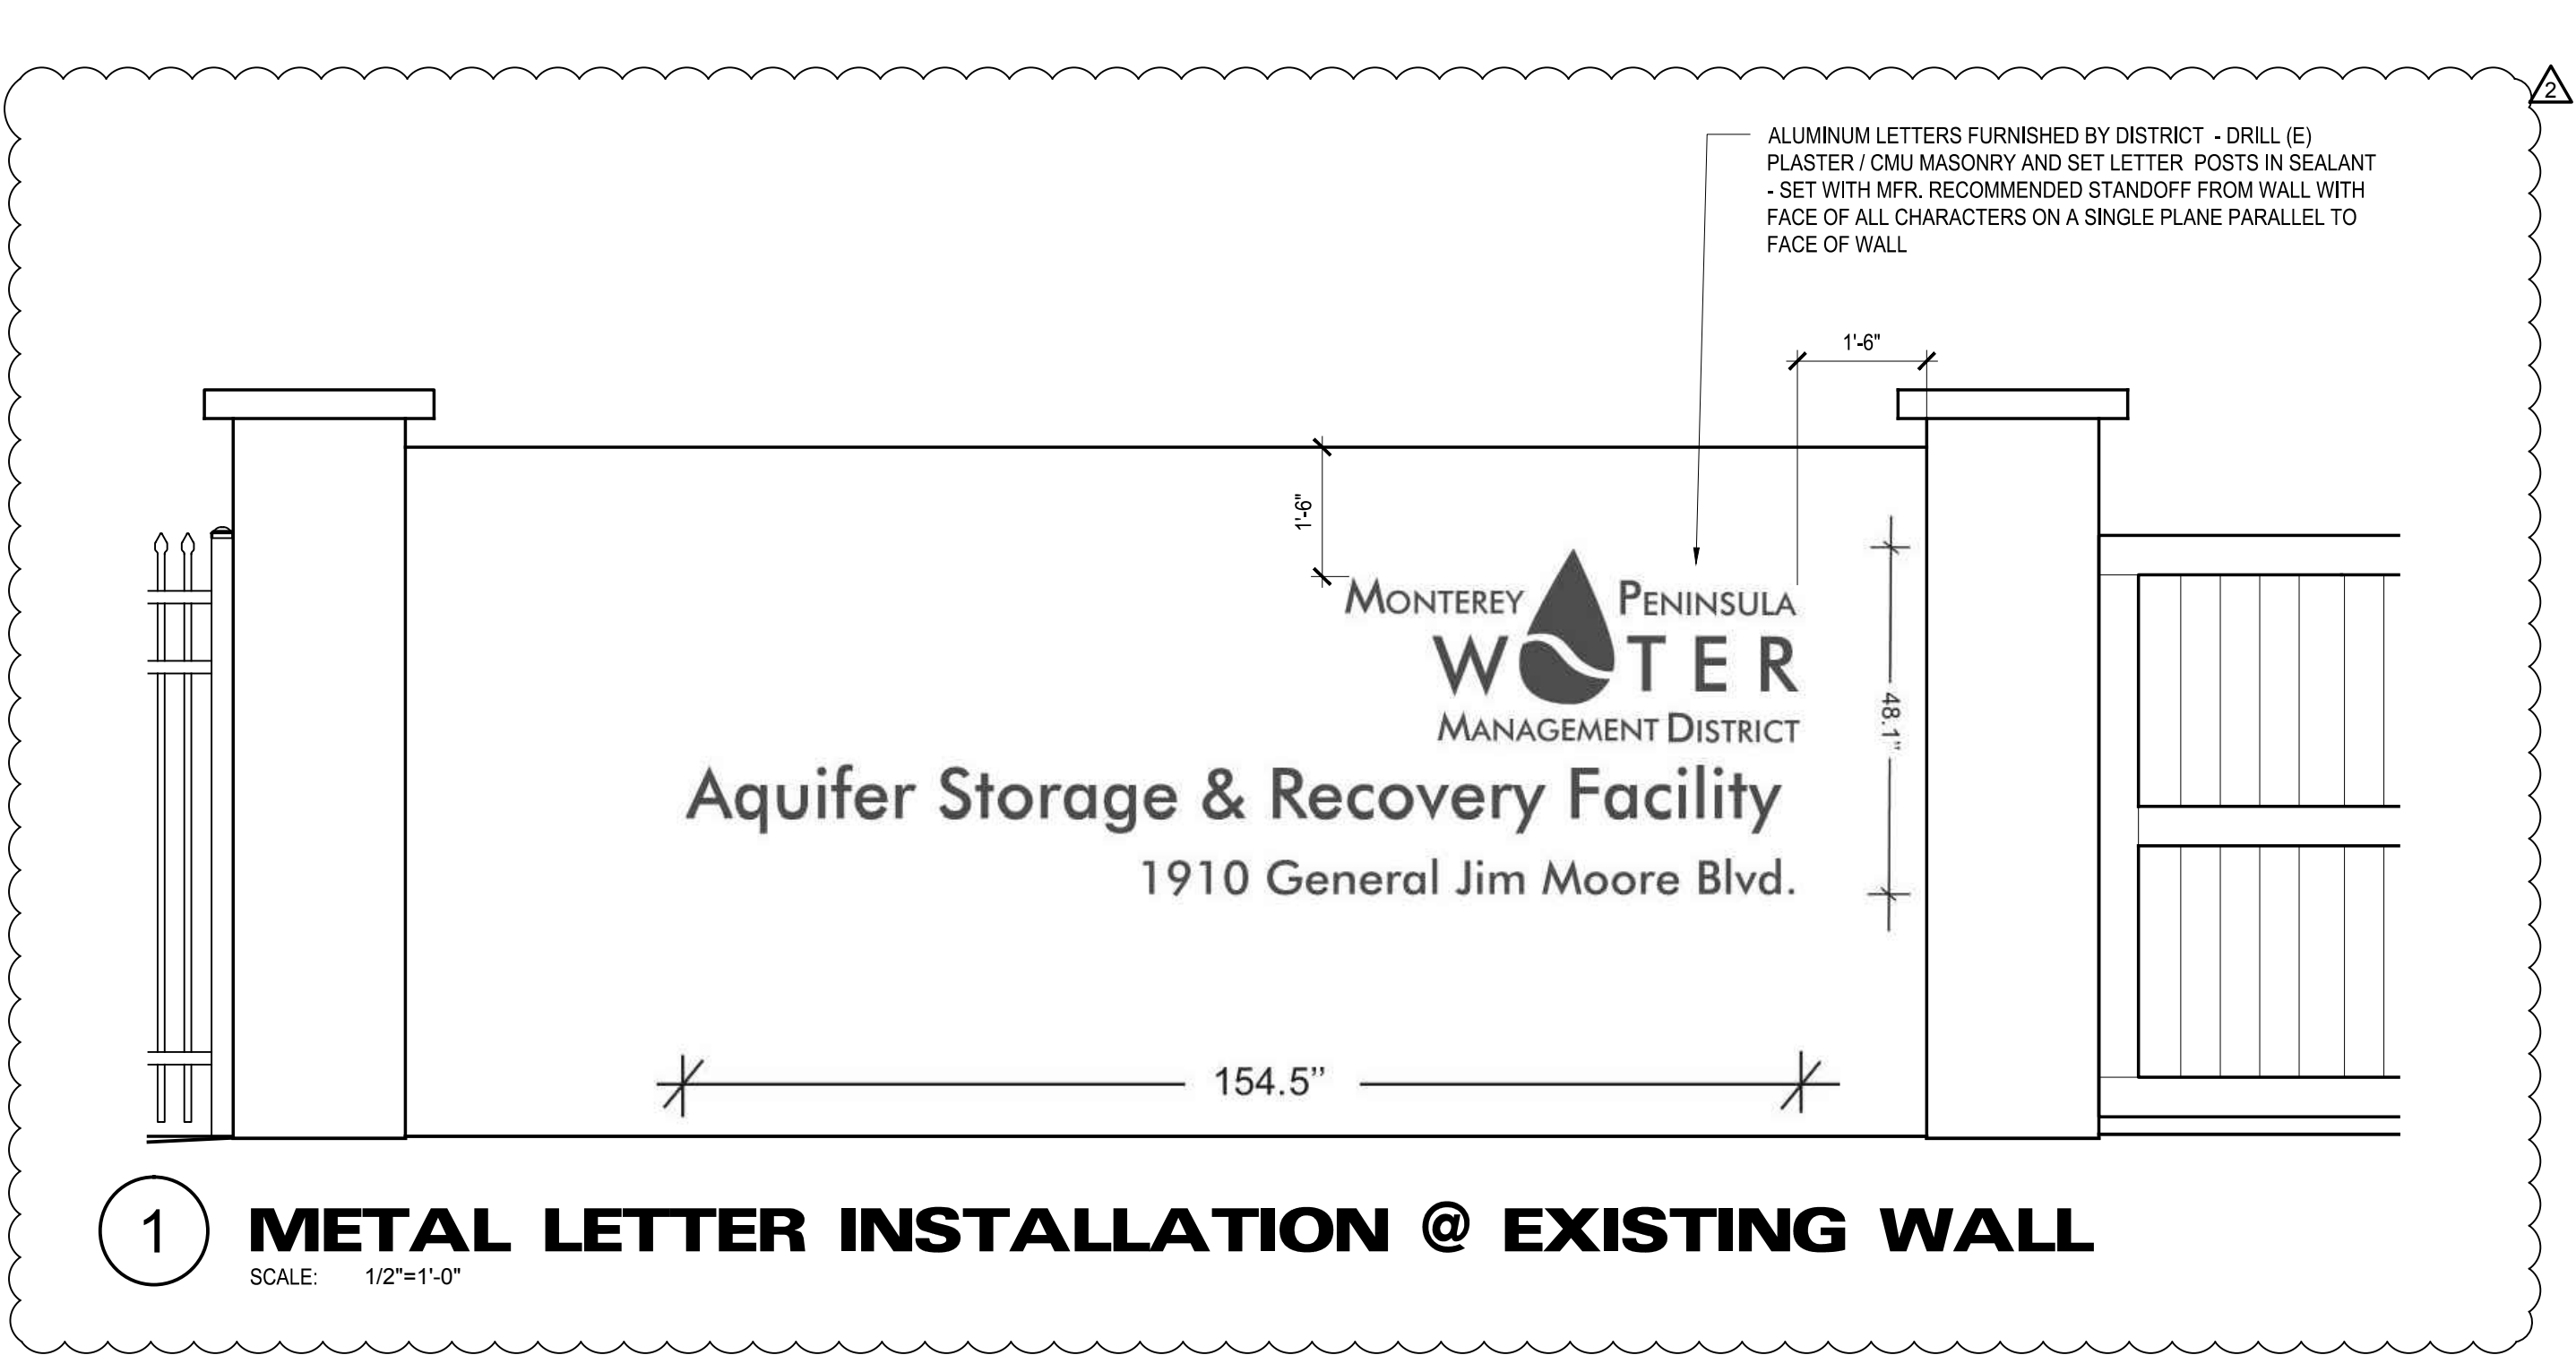

1 METAL LETTER INSTALLATION @ EXISTING WALL
SCALE: 1/2"=1'-0"



KEY NOTES	
THE KEY NOTES THAT FOLLOW APPLY TO THE DRAWING(S) ON THIS SHEET ONLY. REFER TO FOLLOWING SHEETS FOR NOTES THAT ARE APPLICABLE TO THOSE DRAWINGS.	
1 NEW BUILDING ACCESS DRIVEWAY INCLUDING 5 PARKING SPACES	6 SLIDING GATE CONTROL - KEYPAD STATION
2 EXISTING WALL AND FENCING	7 SLIDING GATE CONTROL - SENSORS IN DRIVEWAY
3 NEW BUILDING	7A EXIT LOOP, CAST IN NEW PAVING PER MFR. INSTUCTIONS
4 NEW CONC. PAVING, SEE DETAIL 1/ A111	7B INSIDE SAFETY LOOP, CAST IN NEW PAVING PER MFR. INSTUCTIONS
5 NEW ROLLING GATE	7C OUTSIDE SAFETY LOOP, INSTALL IN SAWCUT KERFS IN (E) PAVING PER MFR. INSTUCTIONS
5A CONCRETE / STEEL TRACK, SEE DETAIL 3/A111	8 FOUNDATION SUB DRAIN SYSTEM
5B GATE MOTOR ON CONCRETE PAD, SEE DETAIL 4/A111	8A APPROXIMATE LOCATION OF EXISTING SITE AREA DRAIN SYSTEM
5C STEEL TUBE ROLLING GATE WITH WOOD CLADDING, SEE DETAILS 4/A111 AND 5/A111	8B NEW SUB DRAIN FOUNDATION PIPE, 4" PERFORATED SCHEDULE 40 PVC PIPE, SEE DETAIL 5/S4.0 FOR INVERT HEIGHT
	8C NEW SUB DRAIN DRAINAGE PIPE, 4" SOLID SCHEDULE 40 PVC PIPE, SLOPE 1% MIN. TO P.O.C. AT EXISTING AREA DRAIN SYSTEM PIPE. VERIFY EXACT LOCATION (E) INVERT FOR NEW DRAIN P.O.C. PRIOR TO PROCEEDING WITH ANY NEW DRAIN INSTALLATION WORK
	9 NEW STAND ALONE COLUMN MATCHING CONSTRUCTION OF EXISTING PILASTER AT OPP. SIDE OF DRIVEWAY, SEE DETAIL 7/A111
	10 INSTALL METAL LETTERS ON EXISTING WALL, METAL LETTERS FURNISHED BY DISTRICT, SEE ELEVATION 1/A101 (ON THIS SHEET)

WR&D
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PARTIAL SITE PLAN
SCALE: 1" = 10'-0"

MPWMD SANTA MARGARITA ASR FACILITY
CHLORINATION BUILDING


1910 GENERAL JIM MOORE BLVD.
SEASIDE, CA

JOB NO.:	18014.2
PRINT DATE:	
PLOT DATE:	9.5.2019
CHECKED BY:	
SET ISSUED:	
60% DESIGN REVIEW	5/17/19
100% DESIGN REVIEW	6/25/19
ISSUED FOR BID	8/5/19
△ BID ADDENDUM #1	8/27/19
△ BID ADDENDUM #2	9/4/19

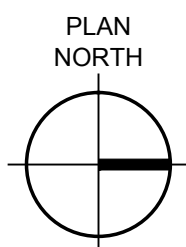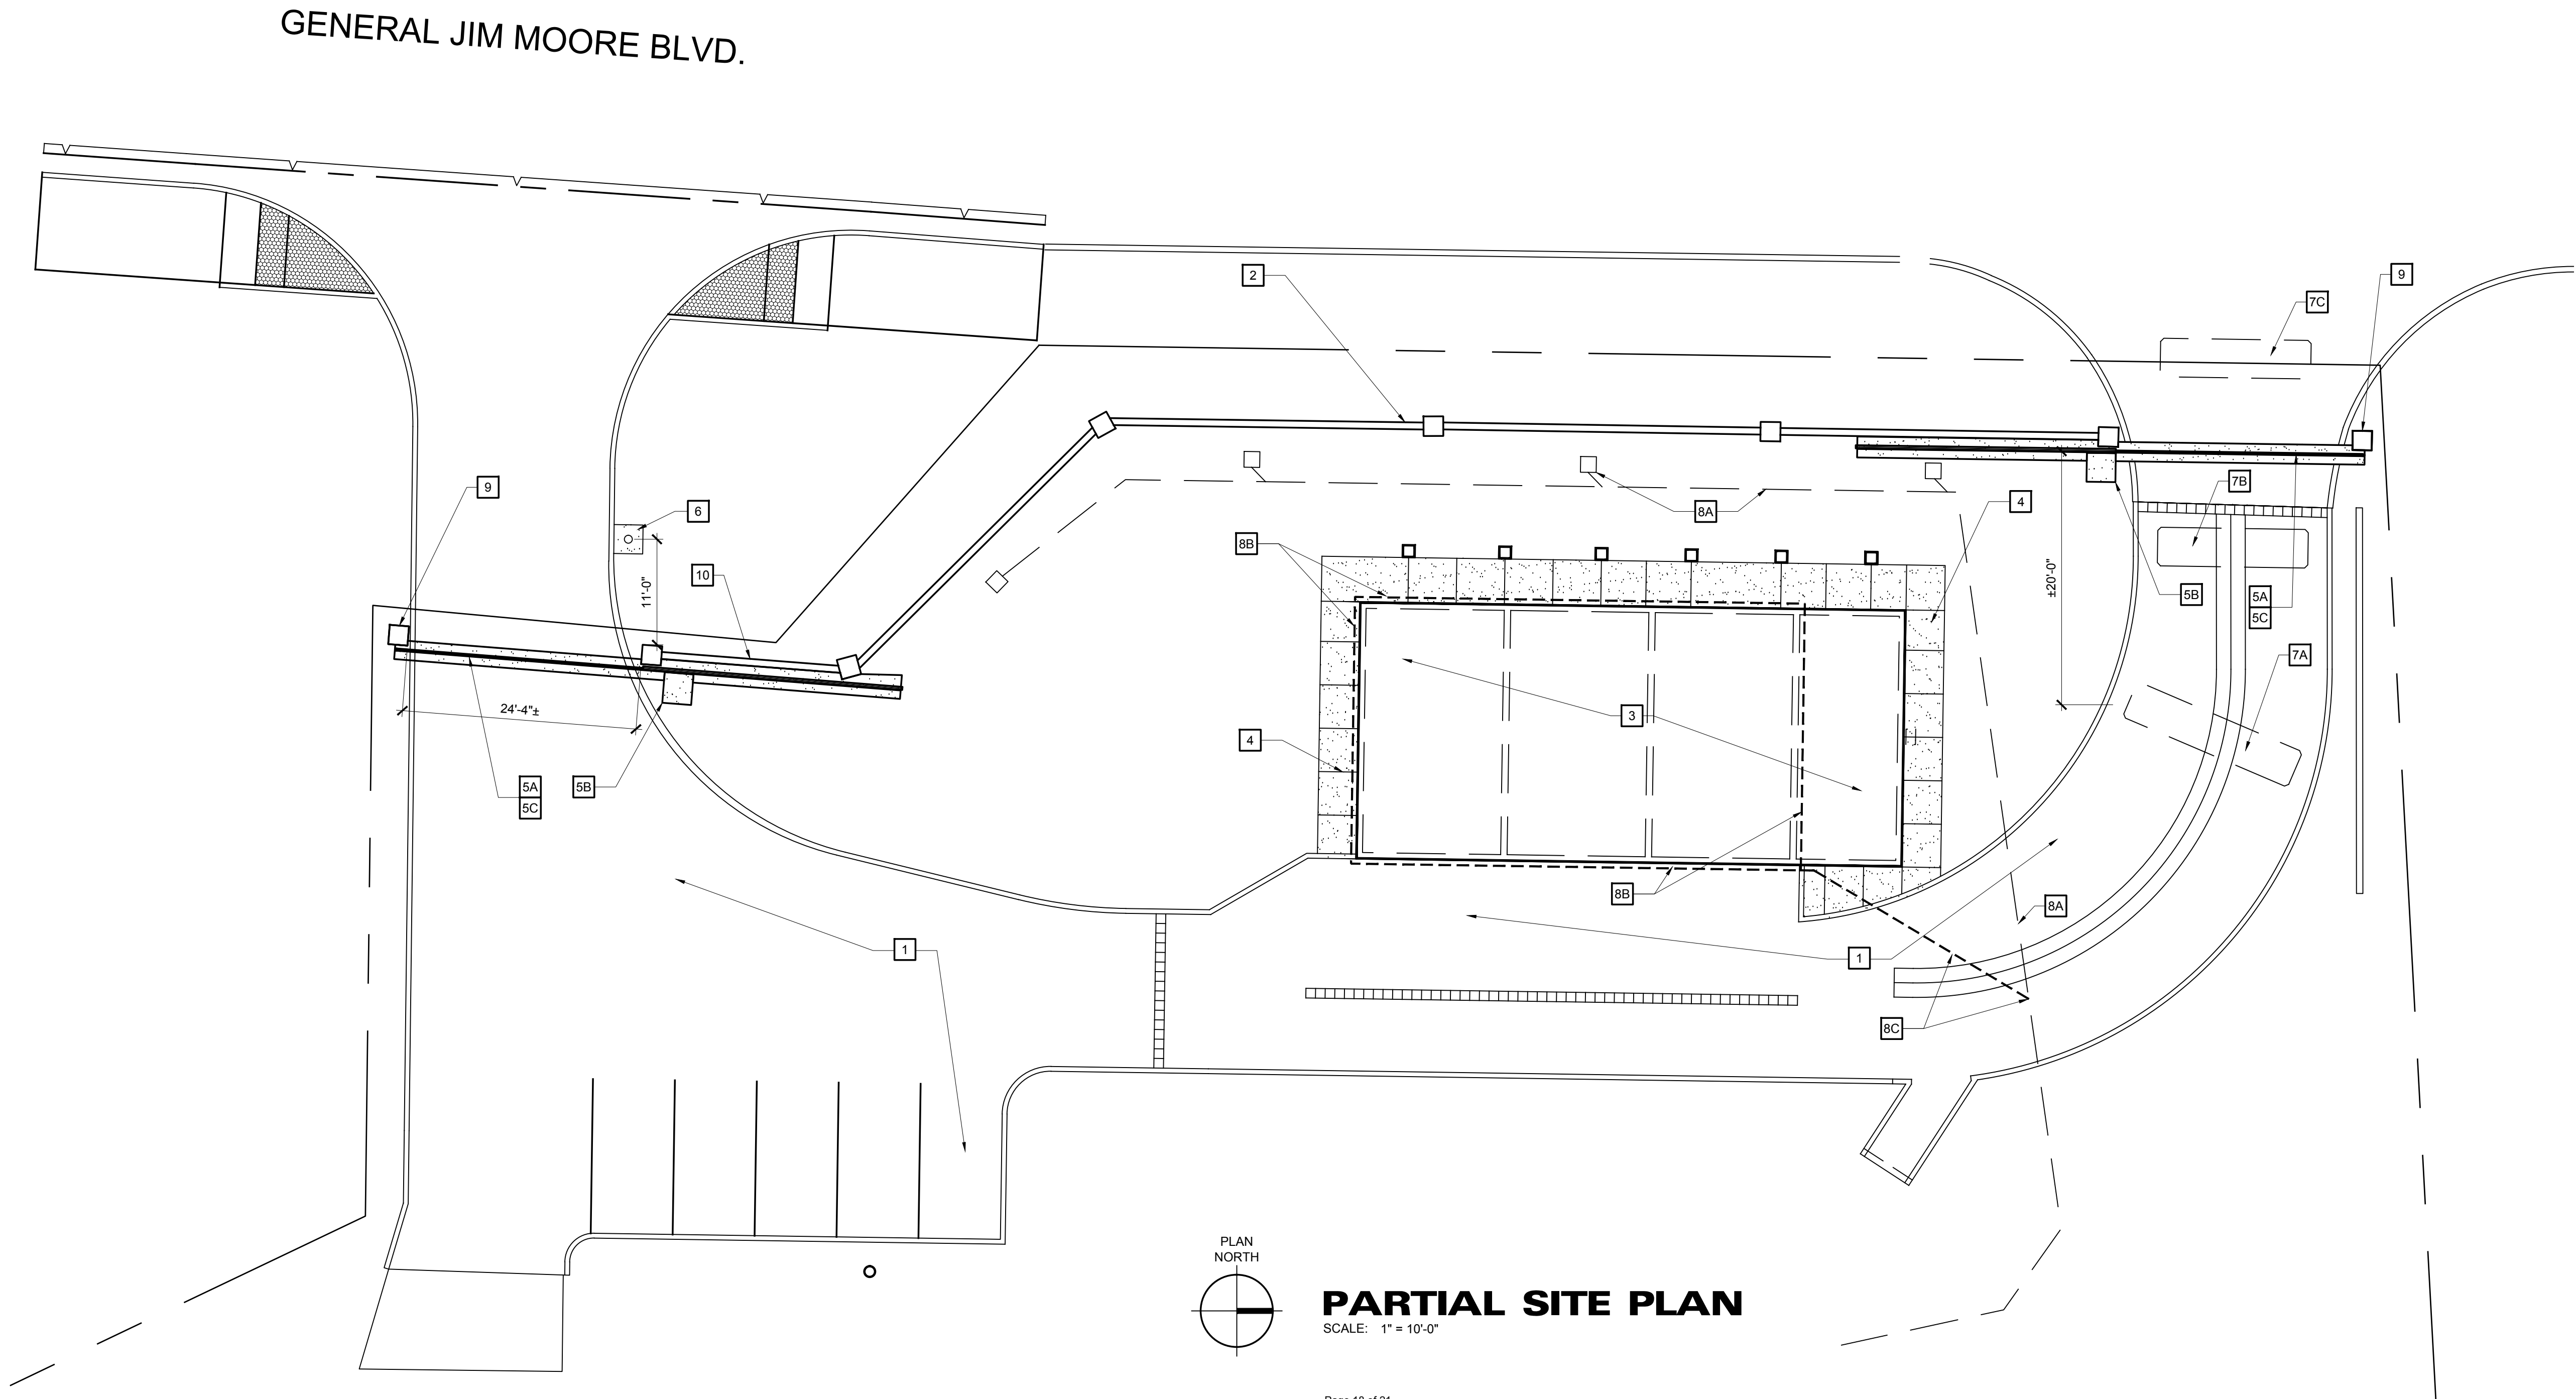
SHEET NAME:
**PARTIAL
SITE
PLAN**

SHEET NO.:
A101


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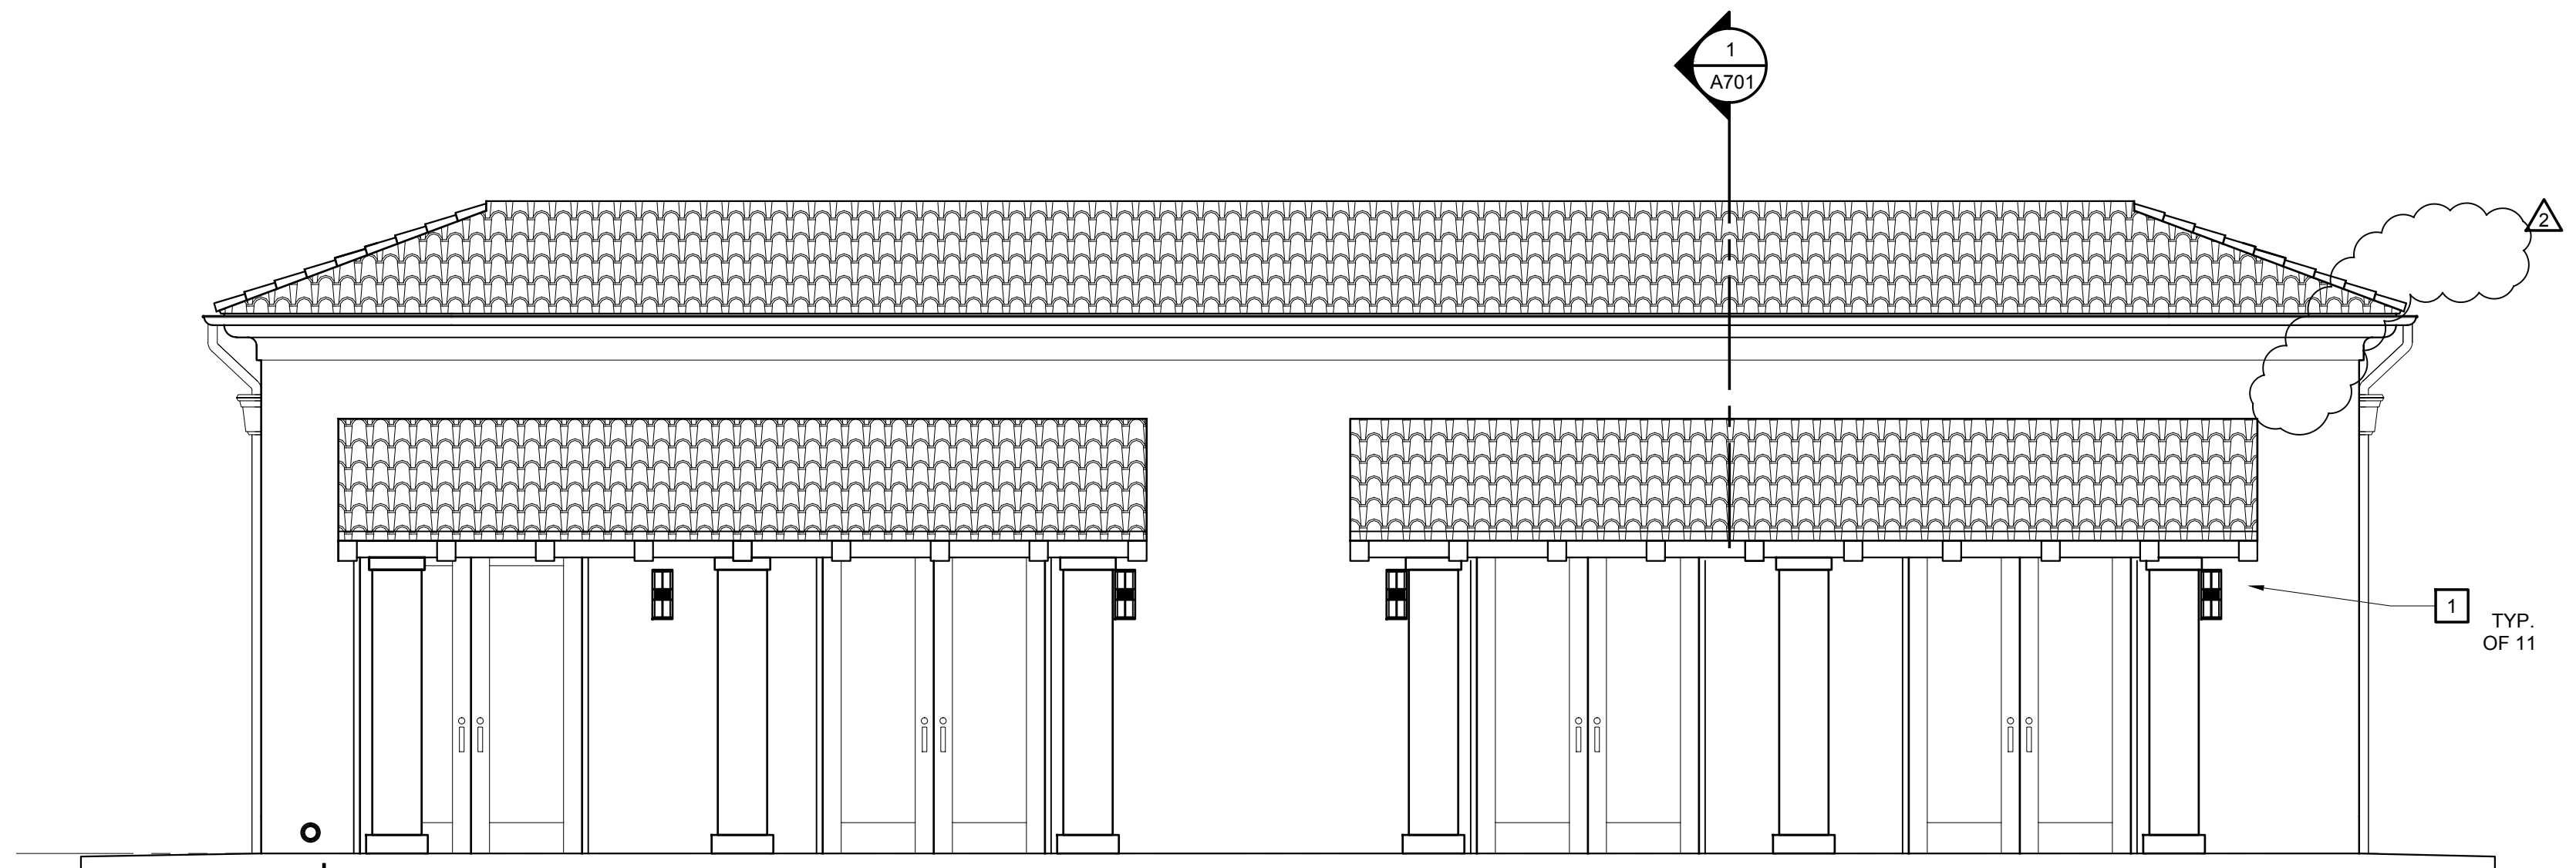
1 **NORTH ELEVATION**
SCALE: 1/4" = 1'-0"

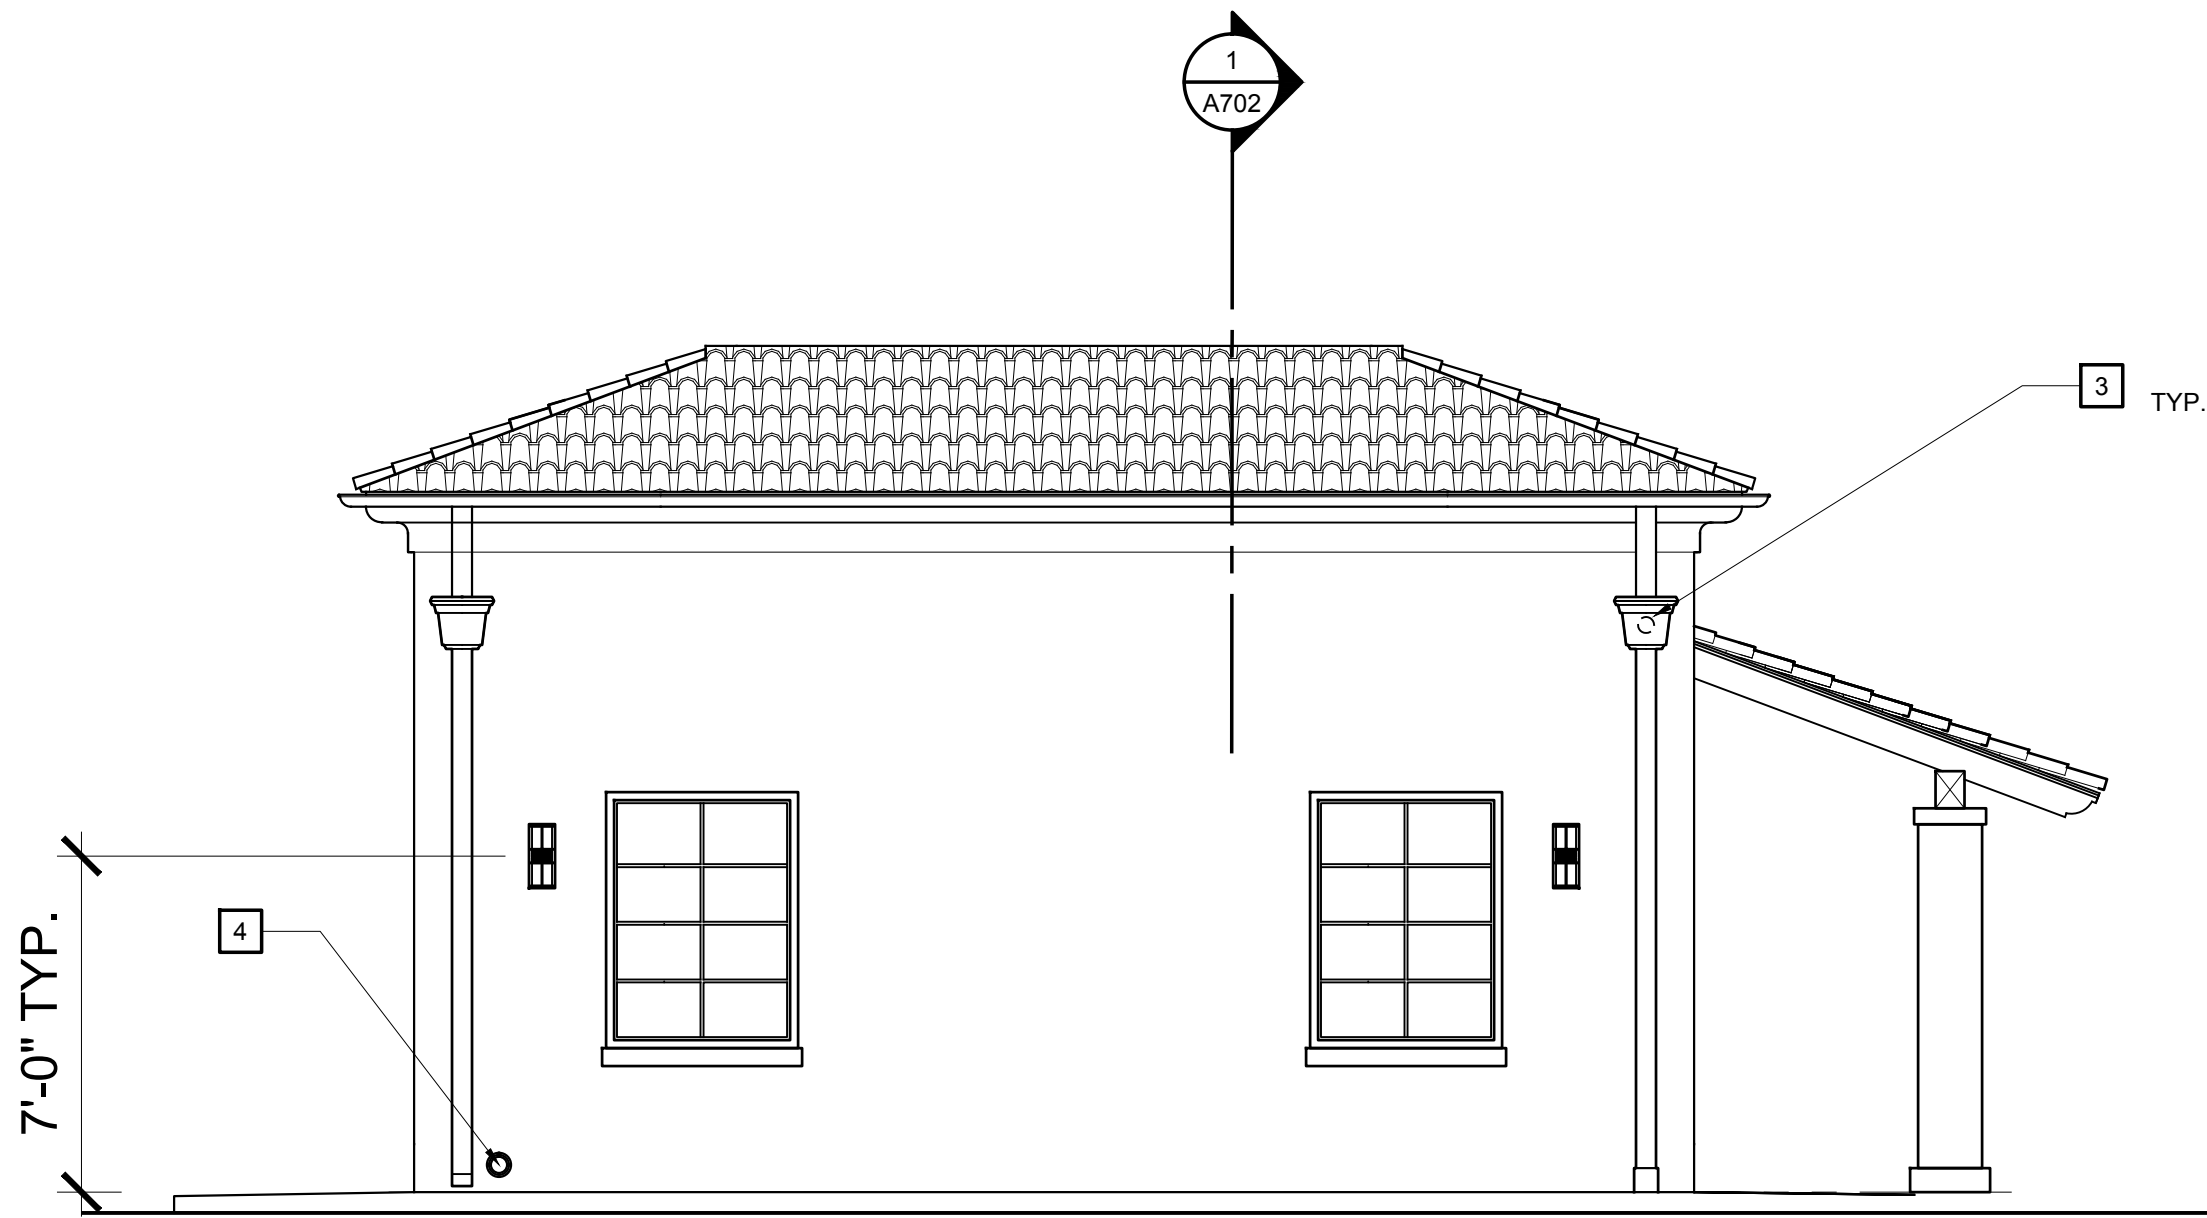


2 **EAST ELEVATION**
SCALE: 1/4" = 1'-0"

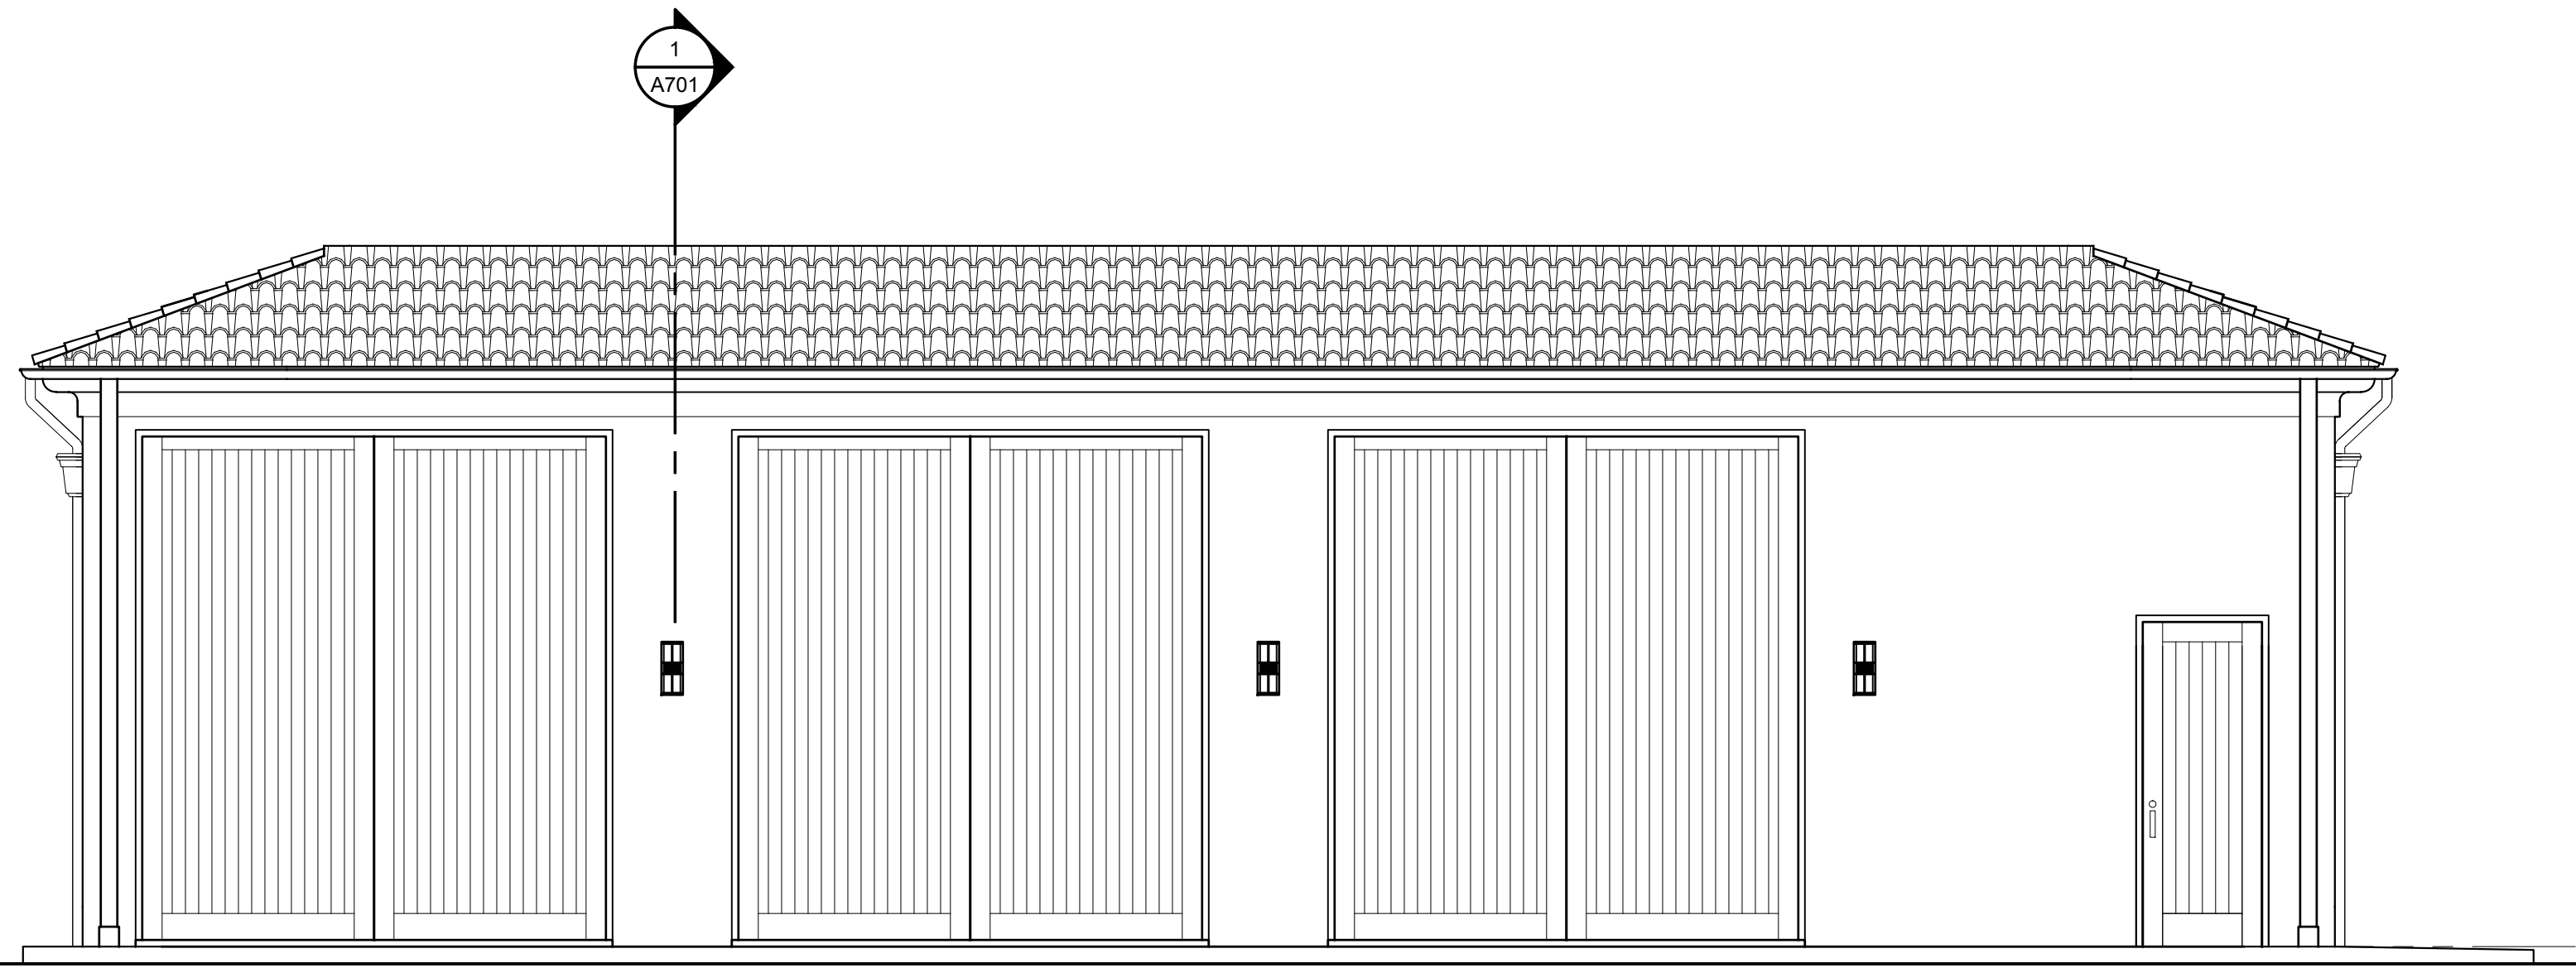

3 **SOUTH ELEVATION**
SCALE: 1/4" = 1'-0"

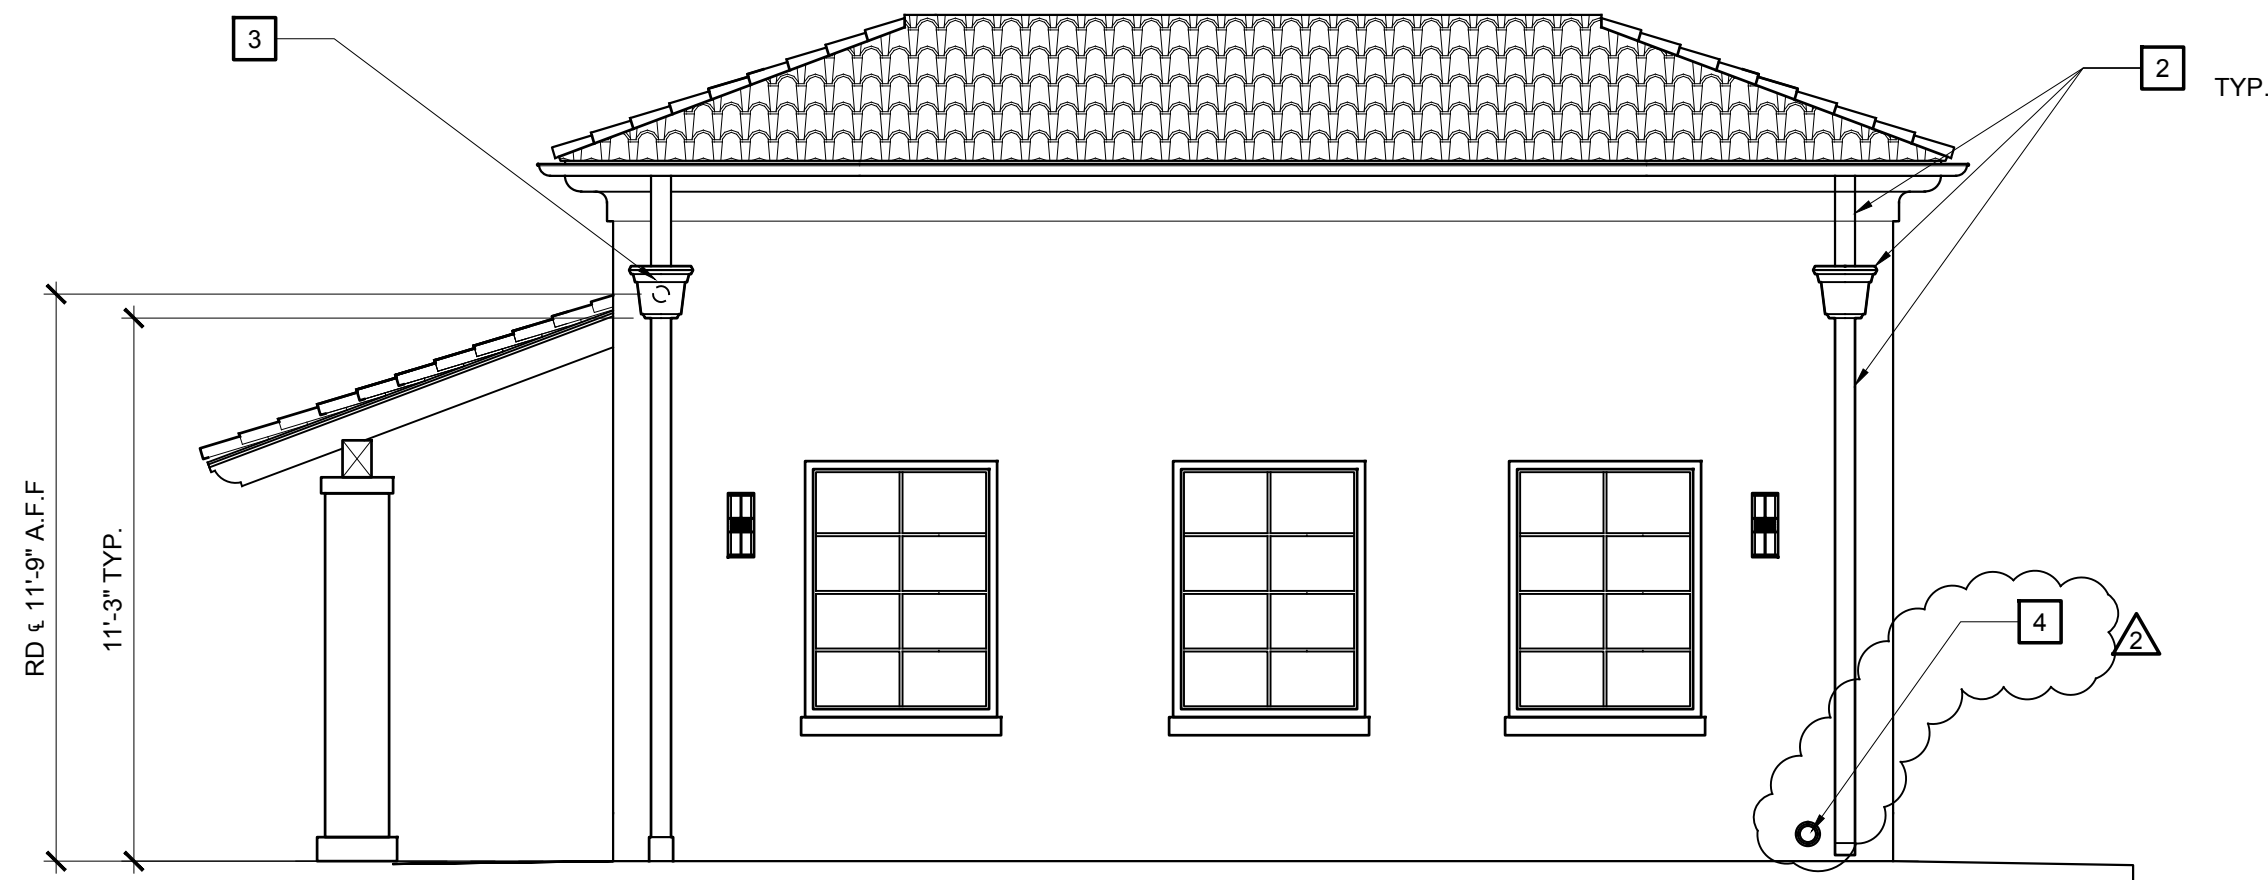

4 **WEST ELEVATION**
SCALE: 1/4" = 1'-0"

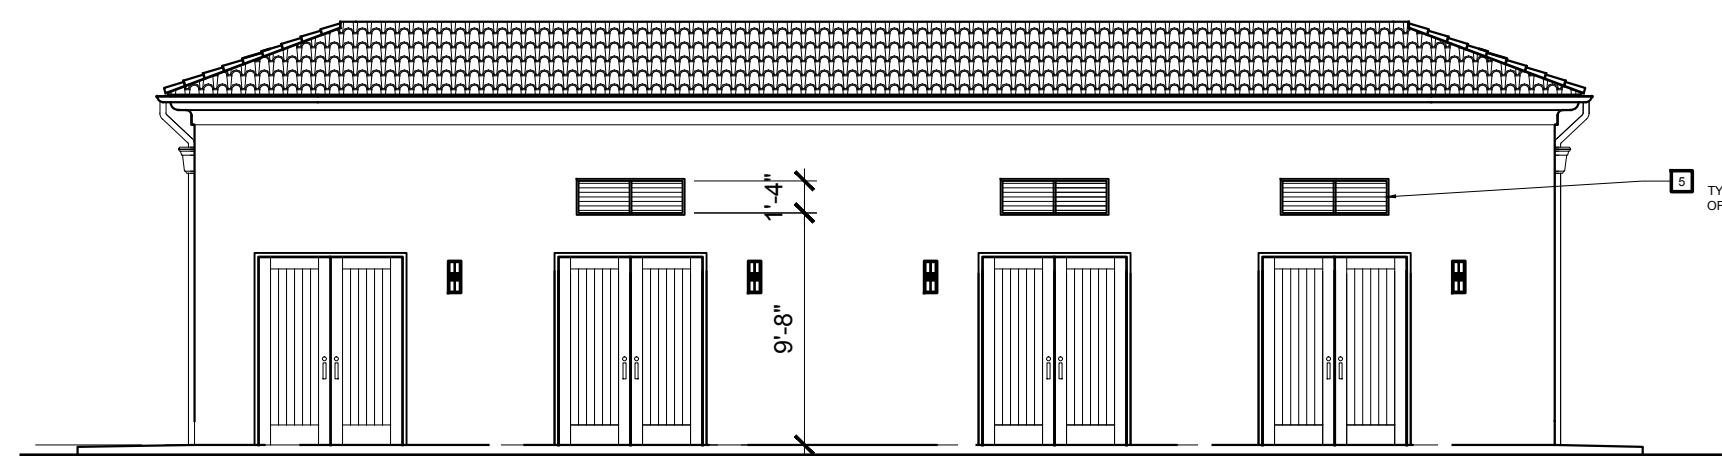

5 **WEST ELEVATION @ WALL**
SCALE: 1/8" = 1'-0"

KEY NOTES

THE KEY NOTES THAT FOLLOW APPLY TO THE DRAWING(S) ON THIS SHEET ONLY. REFER TO FOLLOWING SHEETS FOR NOTES THAT ARE APPLICABLE TO THOSE DRAWINGS.

- 1 WALL MOUNTED LIGHTING FIXTURE, SEE FLOOR PLAN
- 2 COPPER GUTTER / CONDUCTOR HEAD / DOWNSPOUT SYSTEM, SEE ROOF PLAN
- 3 ROOF DRAIN LEADER THROUGH WALL INTO BACK OF CONDUCTOR HEAD, SEE ROOF PLAN
- 4 OVERFLOW ROOF DRAIN LEADER TROUGH WALL INSIDE CLAY TILE PIPE, SEE ROOF PLAN
- 5 MECHANICAL LOUVER, SEE MECHANICAL DRAWINGS FOR SPECIFICATION

MPWMD SANTA MARGARITA ASR FACILITY
CHLORINATION BUILDING

1910 GENERAL JIM MOORE BLVD.
SEASIDE, CA

JOB NO.:

18014.2

PRINT DATE:

PLOT DATE: 9.5.2019

CHECKED BY:

SET ISSUED:

80% DESIGN REVIEW 5/17/19

100% DESIGN REVIEW 6/25/19

ISSUED FOR BID 8/5/19

BID ADDENDUM #2 9/4/19

SHEET NAME:

EXTERIOR
ELEVATIONS

SHEET NO.:

A401

FILE NAME: 18014.2 A401

End of Addendum No. 2